

INSULATION SCHEDULE

PROVIDE THERMAL INSULATION AS SHOWN ON THE DRAWINGS, WITH THE FOLLOWING MINIMUMS:

EXISTING 2X4 EXTERIOR WALLS AND WALLS BETWEEN HEATED AND UNHEATED SPACES: R-13 BATT INSULATION

NEW 2X6 EXTERIOR WALLS AND WALLS BETWEEN HEATED AND UNHEATED SPACES:

R-19 BATT INSULATION

ROOF INSULATION:

R-30 CLOSED CELL ICYNENE INSULATION AT UNDERSIDE OF ROOF SHEATHING

INSULATE ALL PIPE & MECHANICAL CHASES FOR SOUND.

PROVIDE ROCK WOOL INSULATION OR EQUIVALENT BETWEEN ALL WINDOW AND EXTERIOR DOOR FRAME AND ROUGH FRAMING.

WALL LEGEND

EXISTING WALL

EXISTING WALL TO BE DEMOLISHED

NEW EXTERIOR WALL: WOOD BOARD AND BATT SIDING, WEATHER RESISTIVE AIR BARRIER, PLYWOOD SHEATHING, 2X6 FRAMING, INT. 5/8" GYPSUM WALL BOARD

NEW INTERIOR WALL: 2X4 WOOD FRAMING W 5/8" GYPSUM WALL BOARD BOTH SIDES, PROVIDE MOISTURE RESISTANT DRYWALL AS NOTED ON BLANK

KEYNOTES

X.XX KEYNOTE DESIGNATION

E KEYNOTE TEXT

06.03 24" DEEP CABINETRY BELOW
09.04 36" HIGH COUNTERTOP - SEE INTERIOR ELEVATIONS

11.01 RANGE/ OVEN W/ HOOD ABOVE
11.03 REFRIGERATOR - PROVIDE ELECTRIC OUTLET AT
42" AND COLD WATER HOOK-UP; GE
REFRIGERATOR: 21.2 CUFT STAINLESS W TOP

FREEZER GIEZ1GSHSS

11.04 WASHER AND DRYER STACKED

11.05 NEW CONDENSER WITH ANCHORED SEISMIC
STRAPPING ON 4" MINIMUM CONCRETE PAD 3"
ABOVE GRADE. PROVIDE 1 GFI/WP OUTLET WITHIN
25 FEET OF UNIT AND A DISCONNECT SWITCH BY

25 FEET OF UNIT AND A DISCONNECT SWITCH BY THE UNIT PER CEC 210.63.

22.04 KITCHEN FAUCET SHALL NOT EXCEED A WATER

FLOW OF 1.8 GPM

22.06 TOILETS SHALL BE 1.28 GPF MAX

22.07 NEW TANKLESS WATER HEATER- INSTALLED IN

ACCORDANCE W/ THE CPC, INCLUDING SECTION 507.2 SEISMIC PROVISIONS, SEE T24 DOCUMENTS & EQUIPENT SCHEDULE FOR ADDITIONAL REQUIREMENTS AND INFORMATION.

22.14 NEW SHOWER CERAMIC TILE TO CIELING ON SIDES OVER CONCRETE FLOAT. FLOOR FLOOR TILE OVER FLOAT SLOPE TO 3" DRAIN WITH 6X6 TILED CURB ON BOTH SIDES.

26.01 NEW 200 AMP ELECTRICAL METER
33.02 (N) GAS METER LOCATION, SEE PLUMBING

CLIENT

CLIENT NAME HERE

DESIGN & PLANNING

Contractor

1263 Mead Ave. Ventura Ca. 93004 Cell: 805-616-0664 Email: Adamstickels@gmail.com

PROJECT

PROJECT NAME HERE

PROJECT ADDRESS HERE

SHEET TITLE

PROPOSED SPANISH FLOOR PLANS

REVISIONS

PROJECT NAME

PROJECT NAME HERE

DATE DRAWN

DATE 10/21/2024

SHEET NO.

A-2.11








OPTION 1 SPAN VIEW OF ENTRY



OPTION 1 SPAN VIEW OF REAR

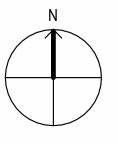

DESIGN & PLANNING

Adam Stickels Contractor

1263 Mead Ave. Ventura Ca. 93004 Cell: 805-616-0664 Email: Adamstickels@gmail.com

CLIENT

CLIENT NAME HERE

PROJECT

PROJECT NAME HERE

PROJECT ADDRESS HERE

SHEET TITLE

3D VIEW OF ADU


REVISIONS


PROJECT NAME HERE PROJECT NAME

DATE DRAWN

SHEET NO.

Δ-2 15

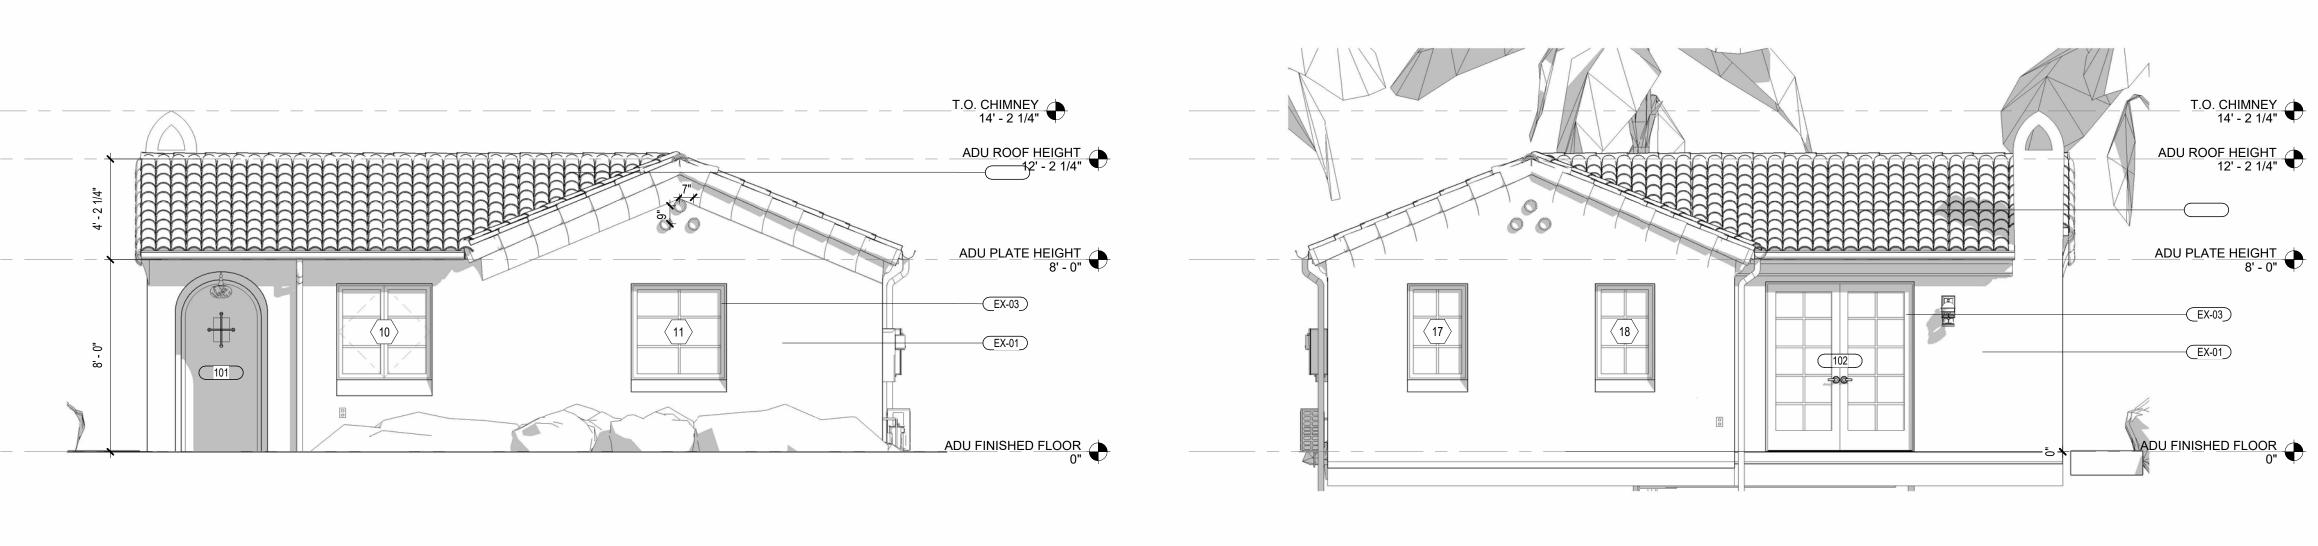

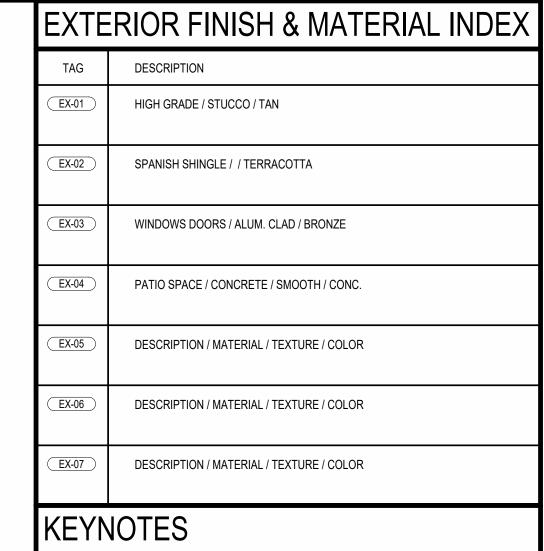

X.XX KEYNOTE DESIGNATION

KEY VALUE KEYNOTE TEXT

22.06 TOILETS SHALL BE 1.28 GPF MAX

23.01 NEW CONDENSER ON CONCRETE PAD

26.02 EXTERIOR WALL MOUNTED SCONCE LIGHT, SEE LIGHTING AND ELECTRICAL PLANS, DARK SKY COMPLIANT MODEL APPROVED BY PLANNING DEPARTMENT

33.01 (N) GAS SUPPLY LINE

CLIENT

CLIENT NAME HERE

DESIGN & PLANNING

Adam

Stickels

Contractor

1263 Mead Ave. Ventura Ca. 93004 Cell: 805-616-0664

Email: Adamstickels@gmail.com

CALE: 1/4" = 1'-0"

PROJECT

PROJECT NAME HERE

PROJECT ADDRESS HERE


SHEET TITLE

PROPOSED EXTERIOR WITH CHIMNEY ELEVATIONS

REVISIONS

PROPOSED NORTH ELEVATION

SCALE: 1/4" = 1'-0"

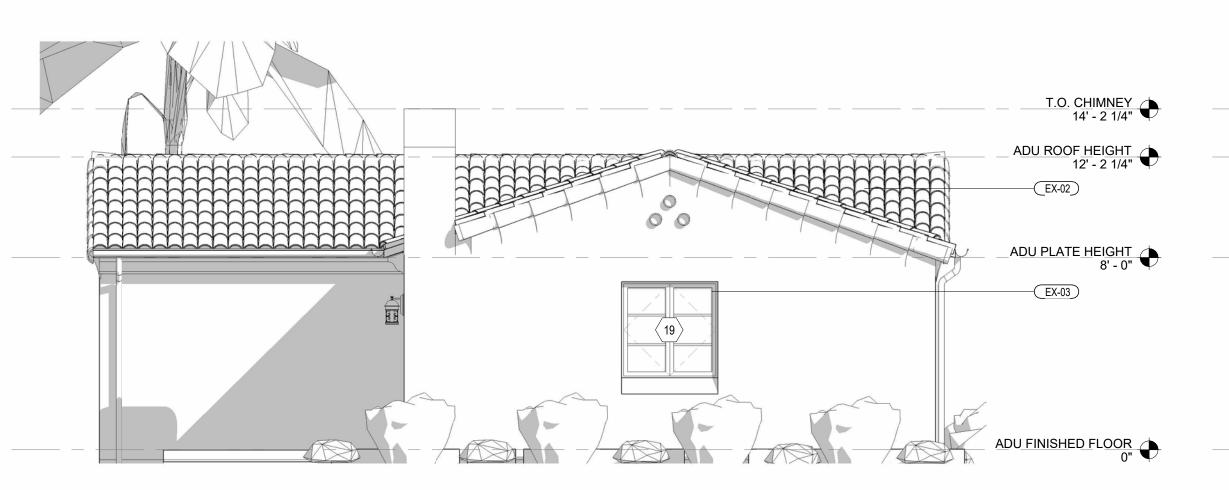



PROPOSED WEST ELEVATION

SCALE: 1/4" = 1'-0"

PROPOSED SOUTH ELEVATION ?

PROPOSED EAST ELEVATION
SCALE: 1/4" = 1'-0"

PROJECT NAME HERE

DATE DRAWN

DATE 10/21/2024
SHEET NO.

A-6.1