



EXISTING



PROPOSED



These plans are the exclusive property of Vogue Signs, Inc. and are the result of original work of it's employees. They are submitted to your company for the sole purpose of your consideration of whether to purchase from Vogue Signs, Inc. Signs manufacture according to these plans. Distribution or exhibition of these plans to anyone other than employees of your company, or use of these plans to construct a sign similar to the ones embodied herein, is expressly forbidden. In the event that such event or exhibition occurs, Vogue Sign, Inc. will charge \$1,500 in compensation for the time and effort in the surveying, research, and creation of Plans.

Project Name: BERKSHIRE HATHAWAY - GOLETA		Date: 10/5/18
Address: 161 FAIRVIEW AVE., GOLETA, CA		Scale: 1/4" = 1' 0"
Draft/Revision: Draft		Drawn: Genaro Gomez
Client Approval:	Date:	Sales: jack Woodruff


THIS SIGN IS INTENDED TO BE INSTALLED IN ACCORDANCE WITH THE REQUIREMENTS OF ARTICLE 600 OF THE NATIONAL ELECTRICAL CODE AND/OR OTHER APPLICABLE LOCAL CODES. THIS INCLUDES PROPER GROUNDING AND BONDING OF THE SIGN.





SCALE: 1/2" = 1' 0"

18.23 SQ.FT.

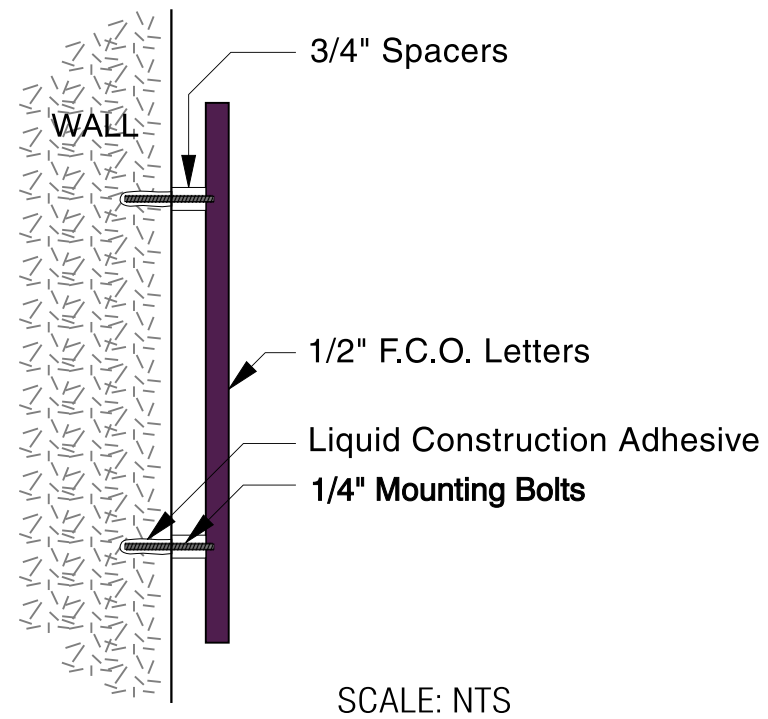


A 1/2" THICK FCO ALUMINUM LETTERS

[1] REQUIRED MANUFACTURE AND INSTALL


GENERAL SPECIFICATIONS

1/2" THICK FCO ALUMINUM LETTERS PAINTED TO MATCH PMS 7859 (CABERNET)
PIN MOUNTED WITH 1" SPACERS TO WALL
EXTERNALLY ILLUMINATED BY OTHERS

DOOR VINYL GRAPHICS
3M HIGH PERFORMANCE WHITE VINYL GRAPHICS
MOUNTED TO FIRST SURFACE OF GLASS DOOR AS SHOWN

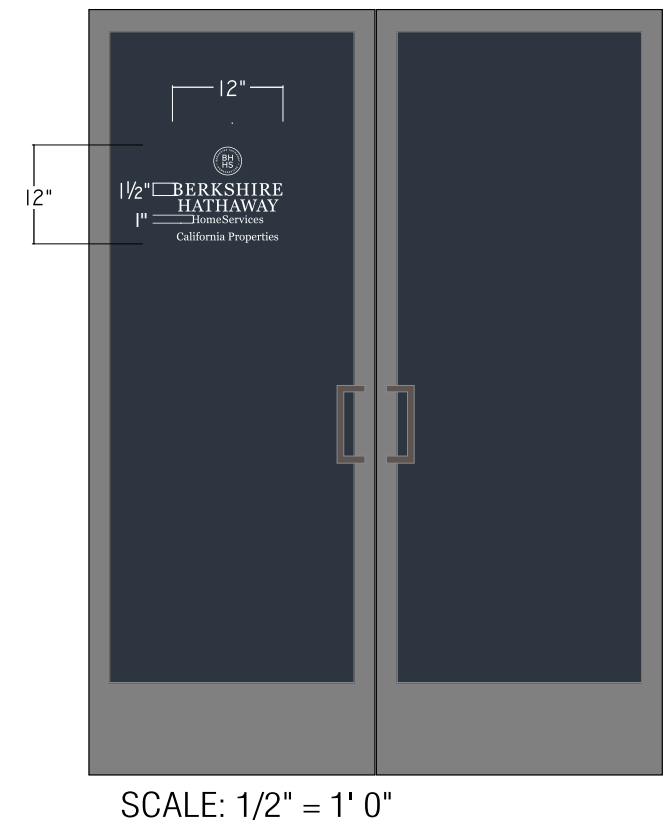

Fairview Shopping Center Site Plan

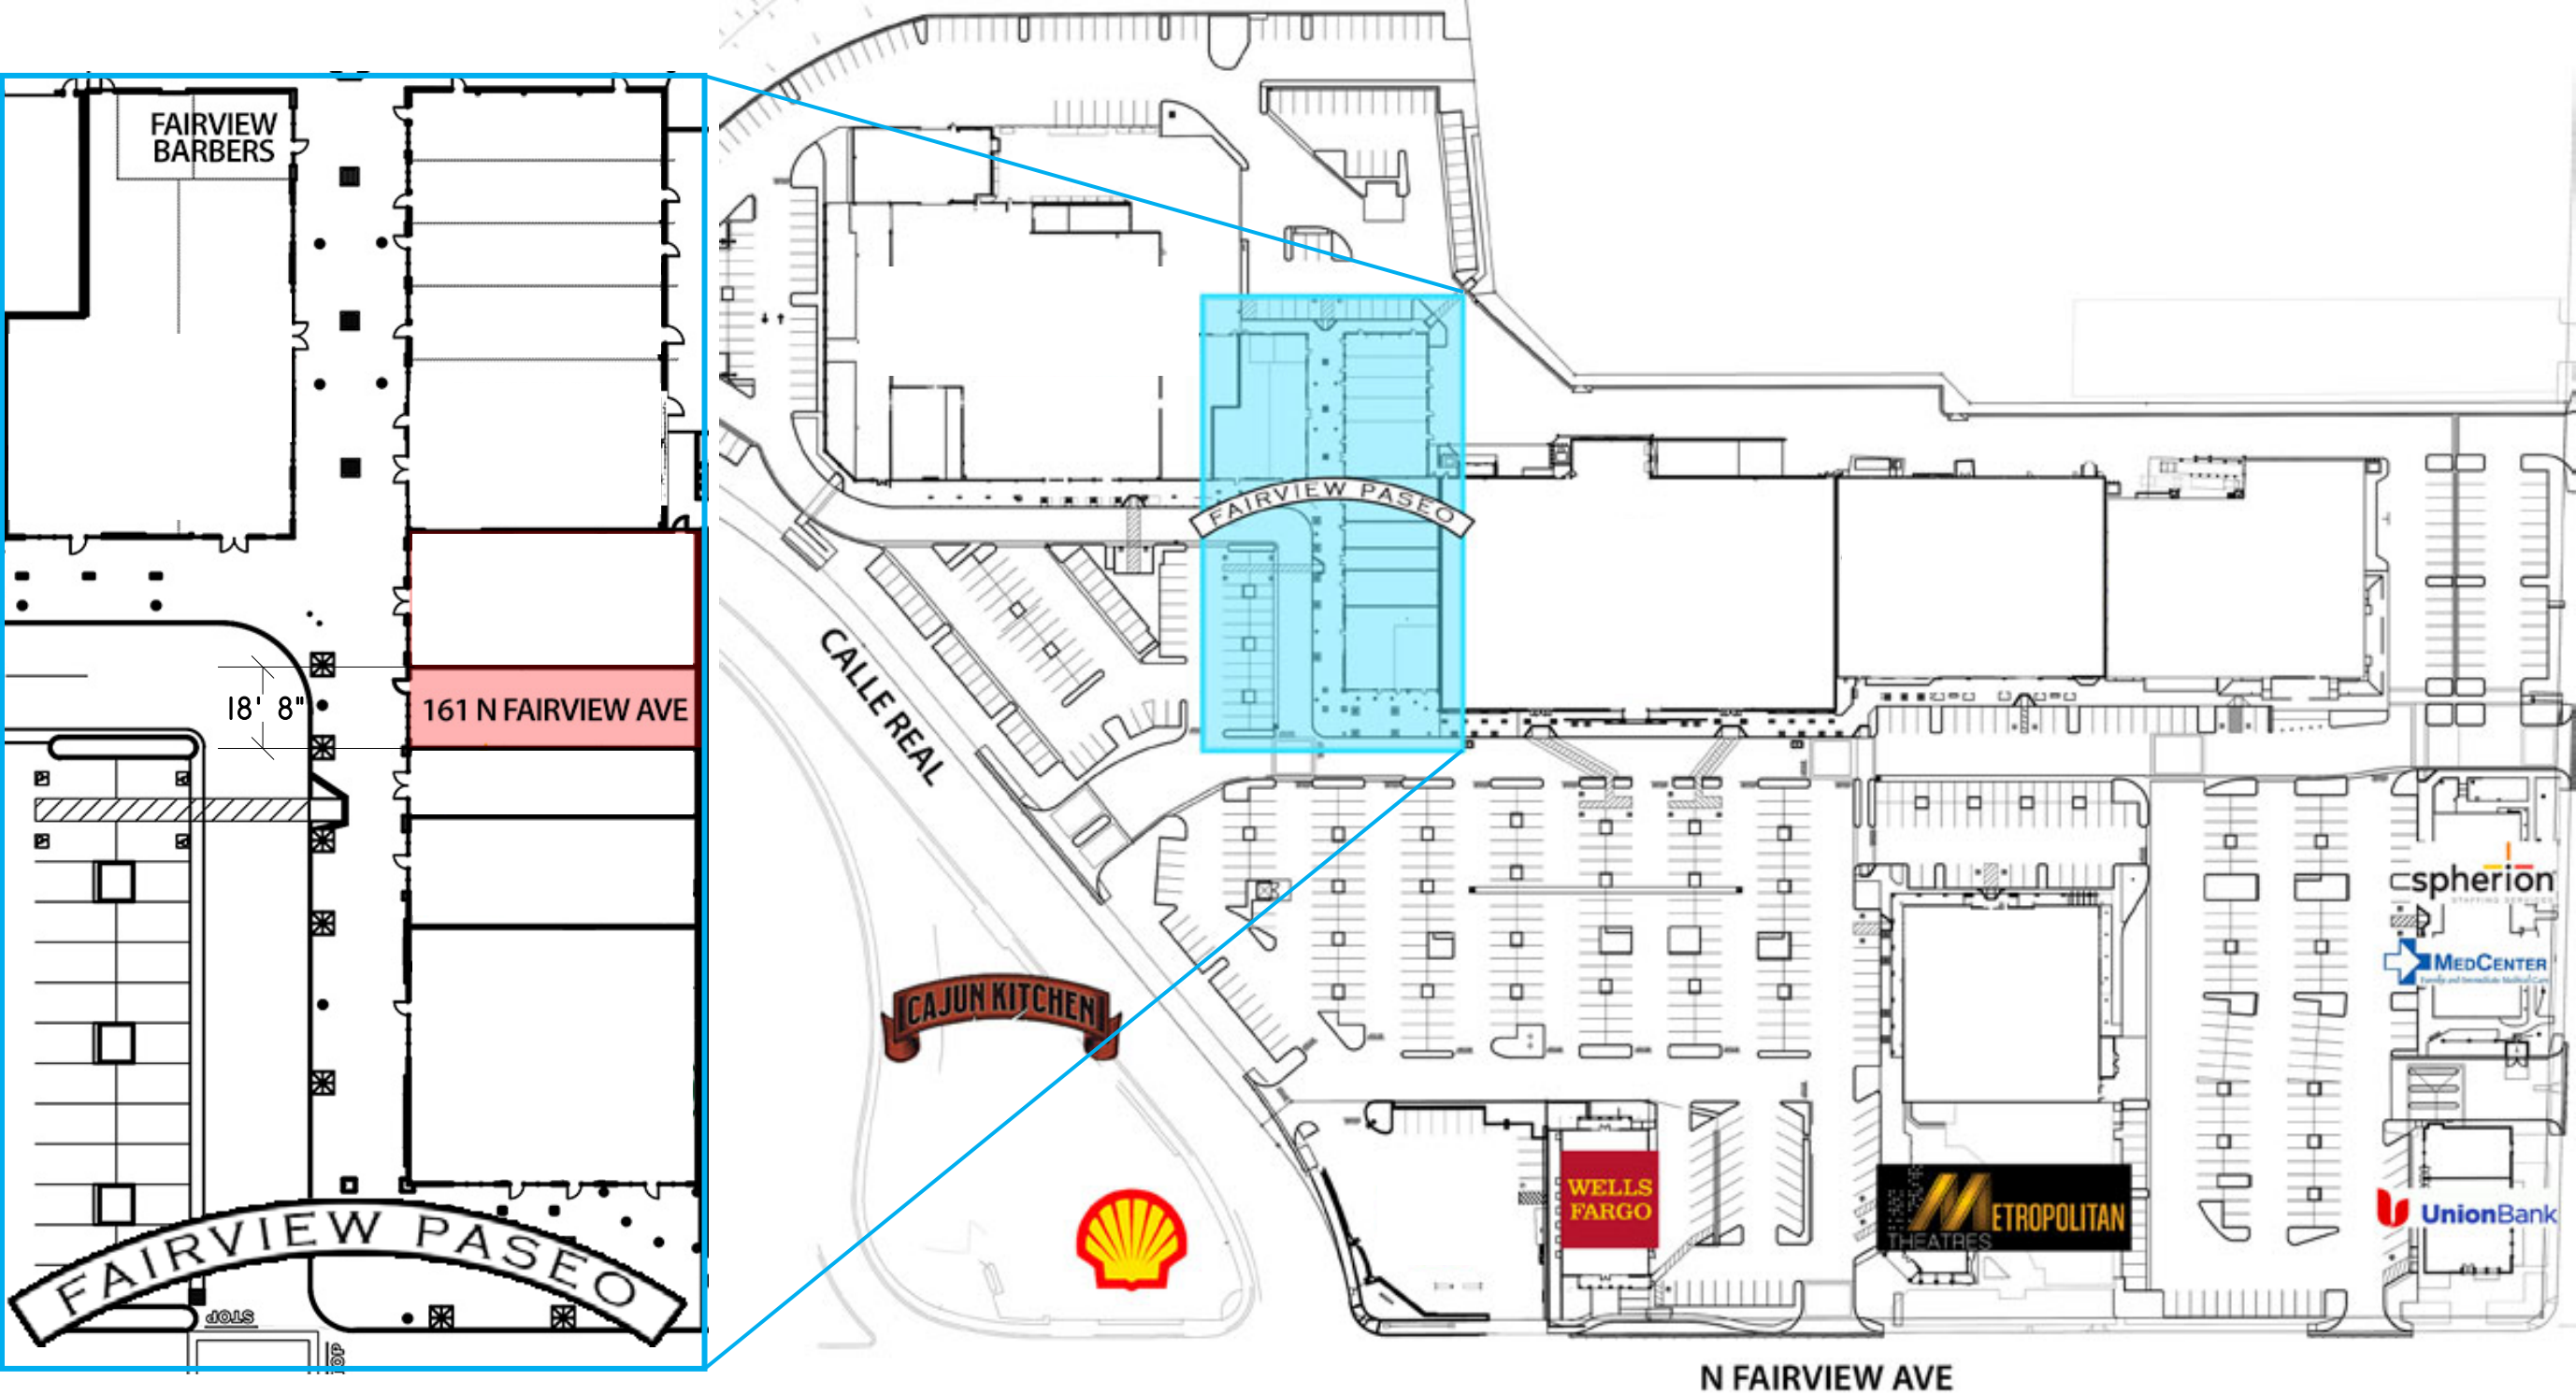

These plans are the exclusive property of Vogue Signs, Inc. and are the result of original work of its employees. They are submitted to your company for the sole purpose of your consideration of whether to purchase from Vogue Signs, Inc. Signs manufacture according to these plans. Distribution or exhibition of these plans to anyone other than employees of your company, or use of these plans to construct a sign similar to the ones embodied herein, is expressly forbidden. In the event that such event or exhibition occurs, Vogue Sign, Inc. will charge \$1,500 in compensation for the time and effort in the surveying, research, and creation of Plans.

Project Name:	BERKSHIRE HATHAWAY - GOLETA	Date:	10/5/18
Address:	161 FAIRVIEW AVE., GOLETA, CA	Scale:	1" = 40' 0"
Draft/Revision:	Draft	Drawn:	Genaro Gomez
Client Approval:	Date:	Sales:	Jack Woodruff

THIS SIGN IS INTENDED TO BE INSTALLED IN ACCORDANCE WITH THE REQUIREMENTS OF ARTICLE 600 OF THE NATIONAL ELECTRICAL CODE AND/OR OTHER APPLICABLE LOCAL CODES. THIS INCLUDES PROPER GROUNDING AND BONDING OF THE SIGN.



VOGUE SIGN
C O M P A N Y
S I N C E 1 9 6 2
715 Commercial Ave. Oxnard, CA 93030 • (805) 485-3411

GN2LED13YAC11B



13 & 26 Watt Angled Cone Shade LED Gooseneck Luminaire designed to match the architecture of Main Street storefronts and building perimeters. LED Gooseneck Cone Shade with 35" Goose Arm Style 2.

Color: Black

Weight: 14.0 lbs

Project:
BHHS Goleta

Type:
Sign

Prepared By:
Erik Lovell

Date:
7-8-18

Driver Info

Type: Constant Current
120V: 0.3A
208V: 0.3A
240V: 0.3A
277V: 0.15A
Input Watts: 16W
Efficiency: 83%

LED Info

Watts: 13W
Color Temp: 3000K (Warm)
Color Accuracy: 86 CRI
L70 Lifespan: 100000
Lumens: 344
Efficacy: 22 LPW

Technical Specifications

Listings

UL Listing:

Suitable for wet locations. Suitable for mounting within 1.2m (4ft) of the ground.

IESNA LM-79 & IESNA LM-80 Testing:

RAB LED luminaires and LED components have been tested by an independent laboratory in accordance with IESNA LM-79 and LM-80.

LED Characteristics

Lifespan:

100,000-hour LED lifespan based on IES LM-80 results and TM-21 calculations

LED:

Single multi-chip, 13W high-output, long-life LED

Color Stability:

LED color temperature is warrantied to shift no more than 200K in CCT over a 5 year period

Color Uniformity:

RAB's range of CCT (Correlated Color Temperature) follows the guidelines of the American National Standard for Specifications for the Chromaticity of Solid State Lighting (SSL) Products, ANSI C78.377-2017.

Construction

Fixture:

The GN2LED13YAC11B comes with the GOOSE2B arm

Housing:

Precision die-cast aluminum housing, lens frame and mounting plate

Gaskets:

High Temperature Silicone

Mounting:

Heavy-duty mounting arm with "O" ring seal and stainless steel screw

Cold Weather Starting:

Minimum starting temperature is -40°C (-40°F)

Finish:

Formulated for high-durability and long lasting color

Green Technology:

Mercury and UV-free. RoHS compliant components. Polyester powder coat finish formulated without the use of VOCs or toxic heavy metals.

Electrical

Driver:

Constant Current, Class 2, 100-277V, 50/60 Hz, 100-240VAC 0.3 - 0.15A, 277VAC 0.15A, THD ≤20%, PF 97.5%.

Surge Protection:

4kv

Other

Shades:

11" Angled Cone Shade offered

Patents:

The design of the Gooseneck is protected by patents pending in US, Canada, China and Taiwan

Warranty:

RAB warrants that our LED products will be free from defects in materials and workmanship for a period of five (5) years from the date of delivery to the end user, including coverage of light output, color stability, driver performance and fixture finish. RAB's warranty is subject to all terms and conditions found at


Equivalency:

Equivalent to 75W incandescent, 50W Metal Halide or 18W CFL

Buy American Act Compliance:

RAB values USA manufacturing! Upon request, RAB may be able to manufacture this product to be compliant with the Buy American Act (BAA). Please contact customer service to request a quote for the product to be made BAA compliant.

Dimensions

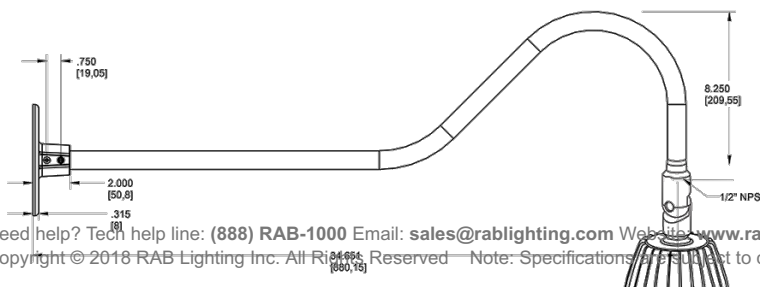

Features

- Adjustable 45° swivel joint
- Superior heat sink
- Die-cast aluminum housing
- 5-Year, No-Compromise Warranty

Need help? Tech help line: (888) RAB-1000 Email: sales@rablighting.com Website: www.rablighting.com

Copyright © 2018 RAB Lighting Inc. All Rights Reserved. Note: Specifications are subject to change at any time without notice

Page 1 of 2

GN2LED13YAC11B



Ordering Matrix						
Family	Wattage	Color Temp	Reflector	Shade	ShadeSize	Finish
GN2LED	13	Y	^	AC	11	B
	13 = 13W	Y = 3000K (Warm)	Blank = Flood	AC = Angled Cone	11 = 11"	B = Black
	26 = 26W	N = 4000K (Neutral)	R = Rectangular		Blank = 15"	W = White
			S = Spot			A = Bronze
						S = Silver
						G = Hunter Green
						YL = Yellow
						LB = Light Blue
						BL = Royal Blue
						BWN = Brown
						I = Ivory
						R = Red