CHABAD OF S. BARBARA PROPOSED DEVELOPMENT PLAN

DEVELOPMENT PLAN / CONDITIONAL USE PERMIT

PROJECT DIRECTORY

CLIENT: CHABAD OF S. BARBARA 6045 Stow Canyon Road Goleta, CA 93117 Ph. (805) 896-7265 Mendel Loschak

rabbimendel@sbchabad.org

ARCHITECT: JEFFREY BERKUS ARCHITECTS, INC. 924 Anacapa Street, Suite 1B

> Santa Barbara, CA 93101 Ph. (805) 963-8902 Jeffrey Berkus, AIA, Principal jeff@berkusdesign.com

LAND USE / AGENT: **SUZANNE ELLEDGE PLANNING &**

TBD

PERMITTING SERVICES, INC. 1625 State Street, Suite 1 Santa Barbara, CA 93101 Ph. (805) 966-2758 x 101 Steve Fort stevef@sepps.com

CIVIL ENGINEER: **MAC Design Associates**

1933 Cliff Drive, Suite 6 Santa Barbara, CA 93109 Ph. (805) 957-4748 Dale W. Weber, PE

dweber@macdesignsb.com

GENERAL CONTRACTOR:

SURVEYOR:

STRUCTURAL ENGINEER:

Waters Land Surveying, Inc. 5553 Hollister Avenue, Suite 7 Goleta, California 93117

Ph. (805) 967-4416 Barry J. Waters, PLS barrywaters55@gmail.com

GEOTECHNICAL ENGINEER:

Pacific Materials Lab 35 South La Patera Lane Goleta, CA 93117 Ph. (805) 964-6901 Ron Pike

pml@pml.sbcoxmail.com

LANDSCAPE ARCHITECT:

Earthform Design 1227 De La Vina Street, Suite A Santa Barbara, CA 93101

Ph. (805) 963-2006 Sam Maphis, ASLA sam@earthform.com

TRANSPORTATION ENGINEER:

Associated Transportation Engineers 100 North Hope Avenue, Suite 4 Santa Barbara, CA 93101

Ph. (805) 687-4418 Scott Schell, AICP, PTP sschell@atesb.com

BIOLOGY:

Hunt & Associates Biological Consulting Services 5290 Overpass Road, Suite 108 Santa Barbara, CA 93111 Ph. (805) 967-8512 Lawrence Hunt anniella@verizon.net

AMEC FOSTER WHEELER

DR-4.6 / R-SF SINGLE FAMILY RESIDENTIAL

GROSS: 143,312 SQ. FT. (3.29 ACRES) / NET: 128,115 SQ. FT. (2.94 ACRES)

35' PER ORDINANCE: 34'-7 1/4" PROPOSED (AT HIGHEST ARCHITECTURAL PROJECTION

LRA -INCORPORATED NON-VHFHSZ

ARCHAEOLOGY

PROJECT:

FIRE ZONE:

LOT SLOPE:

FLOOD ZONE:

SPRINKLERS:

WATER DISTRICT:

ZONING / LAND USE:

PROPERTY AREA: MAX HEIGHT:

OCCUPANCY TYPE:

FEMA FLOOD ZONE:

104 West Anapamu Street, Suite 204A Santa Barbara, CA 93101 Ph. (805) 962-0992

CHABAD OF S. BARBARA

GOLETA, CA 93117

077-170-044

APPROX. 6%

A-2, A-3

YES

6045 STOW CANYON ROAD

David Stone david.f.stone@amecfw.com **PROJECT INFORMATION**

ABBREVIATIONS

<u>ABBREVIATIONS</u>						
A.DR. A.F.F. A.F.R. A.P. A.S. A.V. AC.	ACCESS DOOR ABOVE FINISH FLOOR ABOVE FINISH ROOF ACCESS PANEL ALUMINUM SADDLE AUDIO VISUAL ACOUSTIC, ACOUSTICAL	F.E. F.E.C. F.H.C. F.SP. F.D. FDN. FIN.	FIRE EXTINGUISHER FIRE EXTINGUISHER WITH CABINET FIRE HOSE CABINET FIRE STANDPIPE FLOOR DRAIN FOUNDATION FINISH, FINISHED	OA. OBSERV. O.D. O.H. OFF. OPNG. OPP.	OVERALL OBSERVATION OUTSIDE DIAMETER OPPOSITE HAND OFFICE OPENING OPPOSITE	
AC.BD. AC.T. ADD. ADJ. ALT. ALUM. APPROX. ARCH. ASST.	ACOUSTICAL BOARD ACOUSTICAL TILE ADDITIONAL ADJUSTABLE ALTERNATE ALUMINUM APPROXIMATE ARCHITECTURAL ASSISTANT AND	FIXT. FL. FLUOR. FT. OR ' FTG. FURR. FUT. FVC G.C.	FIXTURE FLOOR FLUORESCENT FEET OR FOOT FOOTING FURRING FUTURE FIRE VALVE CABINET GENERAL CONTRACTOR	PASS. P.L. P. LAM. PH. PLAS. PLYWD. PNL. PREFAB. PRIN.	PASSAGE PROPERTY LINE PLASTIC LAMINATE PENTHOUSE PLASTER PLYWOOD PANEL PREFABRICATED PRINCIPAL	
& @ B B.M. B.U.R.	B LABEL DOOR BENCH MARK	GA. GALV. GEN. G.F.R.C. G.F.R.G.	GAGE GALVANIZED GENERAL GLASS FIBER REINFORCED CONCRETE GLASS FIBER REINFORCED GYPSUM	PROD. PROP. PRTN. PTD. QTR.	PRODUCTION PROPERTY PARTITION PAINTED QUARTER	
B.U.R. BD. BIT. BLDG.	BUILT-UP ROOF BOARD BITUMINOUS BUILDING	GL. GR. GUID. GYP.	GLASS, GLAZE GRADE GUIDANCE GYPSUM	QTY.	QUANTITY	
BLK. BLKG. BM. BOT. BRK.	BLOCK BLOCKING BEAM BOTTOM BRICK	GYP. BD. H.C. H.M. H.P. HDWD. HDWR.	GYPSUM BOARD HANDICAP, HANDICAPPED HOLLOW METAL HIGH POINT HARDWOOD HARDWARE	R.C.P. RCPT. R.D. R.L. R.O. REC.	RECEPTION ROOF DRAIN RAIN LEADER ROUGH OPENING RECESS	
C. TO C. C.B. C.J. C.L. OR ⁽ L C.M.U. CAB. CEM.	CENTER TO CENTER CHALKBOARD CONTROL JOINT CENTER LINE CONCRETE MASONRY UNIT CABINET CEMENT	HGT. HORIZ. H.V.A.C. I.D. I.P.S.	HEIGHT HORIZONTAL, HORIZONTALLY HEATING VENTILATING AIR CONDITIONING INSIDE DIAMETER IRON PIPE SIZE	REF. REINF. RELOC. REQD. RESIL. REV. RIS.	REFRIGERATOR REINFORCEMENT RELOCATED REQUIRED RESILIENT REVISION RISER	
C.F.R.C. C.F.R.G. CHG. CLG. CLO.	CEMENTITIOUS FIBER REINFORCED CONCRETE CEMENTITIOUS FIBER REINFORCED GYPSUM CHANGE CEILING CLOSET	I.F.S. IN. OR' INCL. INSTR. INSUL. INT. INTER.	INCH OR INCHES INCLUSIVE, INCLUDE, INCLUDING INSTRUCTION INSULATION INTERIOR INTERMEDIATE	RM. RUB. S. S.S. S.F. SCHED.	ROOM RUBBER SOUTH STAINLESS STEEL SQUARE FEET SCHEDULED	
CNTR. COL. COMM. CONC. CONF. CONN. CONST.	COUNTER COLUMN COMMUNICATIONS CONCRETE CONFERENCE CONNECTION CONSTRUCTION	JAN. JT. K.E.C. L.P.	JANITOR JOINT KITCHEN EQUIPMENT CONTRACTOR	SEC. SECT. SH. MT. SHWR. SIM. SK. SPCL.	SECRETARIAL SECTION SHEET METAL SHOWER SIMILAR SKETCH SPECIAL	
CONT. CONTR. CORR. CPT. CTND. CTR. CUST.	CONTINUOUS, CONTINUE CONTRACTOR CORRIDOR CARPET CONTAINED CENTER CUSTODIAL	L.F. LAB. LAD. LAM. LANG. L.A.S.S. LAV. LDR.	LOW POINT LABORATORY LADDER LAMINATED LANGUAGE LAND, AIR, SEA AND SPACE LAVATORY LEADER	SPEC. ST. STD. STL. STOR. STRUCT. SUPP.	SPECIFICATIONS STREET STANDARD STEEL STORAGE STRUCTURAL SUPPORT	
DEPT. DET. DIA. DN. DNSPT. DR.	DEPARTMENT DETAIL DIAMETER DOWN DOWNSPOUT DOOR	L.F. LKR. LOC. LT. LTWT.	LINEAR FEET LOCKER LOCATION LIGHT LIGHTWEIGHT MARKERBOARD	SUSP. T. & G. T.B. T.O.S. T.O.W. TD. TELE. CAB	TONGUE AND GROOVE TACKBOARD TOP OF STEEL TOP OF WALL TREAD . TELEPHONE CABINET	
DWG. E. EA. EDUC. E.I.F.S.	DRAWING EAST EACH EDUCATION EXTERIOR INSULATION AND	M.E.R. M.O. MACH. RM MAS. MAX. MATL.	MECHANICAL EQUIPMENT ROOM MASONRY OPENING . MACHINE ROOM MASONRY MAXIMUM MATERIAL	TELE. THK. THRES. THRU TLT. TRANS. TV	TELEPHONE THICKNESS THRESHOLD THROUGH TOILET ROOM TRANSFER TELEVISION	
E.F.S. EL. ELEC. ELEV. ENCL. ENT.	FINISH SYSTEM EXTERIOR FINISH SYSTEM ELEVATION ELECTRIC ELEVATOR ENCLOSURE ENTRANCE	MECH. MET. MEZZ. MFR. MIN. MISC. MLDG.	MECHANICAL METAL MEZZANINE MANUFACTURER MINIMUM MISCELLANEOUS MOULDING	TYP. U.N.O. U.L. UR. UR.H.	TYPICAL URINAL URINAL HANDICAPPED	
EQ. EQUIP. EXIST. EXP. EXP. JT. EXT.	EQUAL	MTD. N. N.I.C. N.T.S. N.A.	NORTH NOT IN CONTRACT NOT TO SCALE NOT APPLICABLE	V.C.T. V.I.F. V.W.C. VEST. VIT. W.	VERIFY IN FIELD VINYL WALLCOVERING VESTIBULE VITREOUS WEST	
		NO. OR# NOM.	NUMBER NOMINAL	W. GL. W.M. W/ WAINS. WD.	WIRE GLASS WIRE MESH WITH WAINSCOT WOOD	

SCOPE OF WORK

PROPOSED CONSTRUCTION OF 7,236 SQ. FT. (GROSS) SYNAGOGUE WITH 727 SQ. FT. ROOF TERRACE. BUILDING TO PROVIDE SANCTUARY, EVENT HALL WITH KITCHEN, CONFERENCE ROOM, WORK ROOM, TWO OFFICES, STORAGE AND REQUIRED BATHROOMS. NEW STORAGE BUILDING OF 841 SQ. FT. (GROSS) TO ACCOMODATE FOR REMOVAL OF EXISTING BARN STORAGE (1,460 SQ. FT.).

WD. WKRM.

WS-XX

WOOD WORKROOM

STOREFRONT SYSTEM

PROPOSED LANDSCAPING INTEGRATES NEW STRUCTURES WITH EXISTING BUILDINGS WHILE MINIMIZING GRADING. PERMEABLE SURFACE PROPOSED FOR NEW PARKING AREAS. EXISTING, NON-HISTORIC STORAGE GARAGE TO BE REMOVED. PRELIMINARY WATER SERVICE DETERMINATION HAS BEEN RECEIVED FROM GOLETA WATER DISTRICT.

PROJECT DATA

LOT SIZE: **GROSS**: NET:

143,312 SQ. FT. (3.29 ACRES) 128,115 SQ. FT. (2.94 ACRES)

EXISTING BUILDING SQUARE FOOTAGE (GROSS):

SINGLE FAMILY DWELLING: 4,855 SQ. FT. (4,093 sq. ft. int. + 762 sq. ft. ext. deck) EDUCATION / SYNAGOGUE SERVICES: 2,455 SQ. FT. 352 SQ. FT. SPA BUILDING: BARN (TO BE REMOVED): TOTAL SQ. FT. 1,440 SQ. FT. 9,102 SQ. FT

PROPOSED NEW BUILDING SQUARE FOOTAGE (GROSS):

SYNAGOGUE: 7.389 SQ. FT. ROOF TERRACE: 727 SQ. FT. TOTAL SYNAGOGUE & ROOF TERRACE 8,116 SQ. FT

STORAGE BUILDING: 841 SQ.FT.

PROPOSED LOT COVERAGE: **EXISTING BUILDINGS TO REMAIN:**

7,662 SQ. FT. (dwelling+decks/education building/spa) PROPOSED SYNAGOGUE: 7,389 SQ. FT. PROPOSED STORAGE: 841 SQ. FT. **TOTAL BUILDING AREA:** 15,892 SQ. FT.

PROPOSED TOTAL BUILDING LOT COVERAGE (GROSS): 11.1% (15,892 SQ. FT. / 143,312 SQ. FT.)

PROPOSED TOTAL BUILDING LOT COVERAGE (NET): 12.4% (15,892 SQ. FT./ 128,115 SQ. FT.)

PROPOSED LOT COVERAGE BREAKDOWN (GROSS):

92,759 SQ. FT. (64.7%) LANDSCAPE/OPEN SPACE: PARKING/DRIVE AISLES: 10,177 SQ. FT. (7.1%) (pervious) PARKING/DRIVE AISLES: 12,419 SQ. FT. (8.7%) (impervious) PATIOS/WALKWAYS: 12,065 SQ. FT. (8.4%) (impervious) **BUILDING COVERAGE:** 15,892 SQ. FT. (11.1%)

PROPOSED PARKING: 41 SPACES **RESIDENTIAL:** 3 SPACES

SYNAGOGUE: (32) STANDARD (3) COMPACT (3) ACCESSIBLE

REQUIRED PARKING BY CITY: 29 SPACES

per City email dated April 9, 2018; summarized:

a. 21 spaces (81 fixed seats, at 1 space per 4 fixed seats) b. 5 spaces (to allow up to 10 catering staff for large events; 1 space per 2 kitchen employees)

143,312 SQ. FT. (100.0%)

38 SPACES

c. 3 spaces (required for residential homes of 3,000 sq. ft. or more)

SHEET INDEX

GENERAL

A0.00 COVER SHEET

ARCHITECTURAL

A1.00 EXISTING SITE PLAN

A1.01 PROPOSED SITE PLAN

A2.01 MAIN FLOOR PLAN A2.02 TERRACE / ROOF PLAN

A2.03 STORAGE PLAN & ELEVATIONS

A3.01 NORTH & SOUTH ELEVATIONS

A3.02 EAST & WEST ELEVATIONS

A4.01 PARTIAL SITE SECTIONS

C-1 GENERAL INFORMATION

C-2 DEMOLITION PLAN

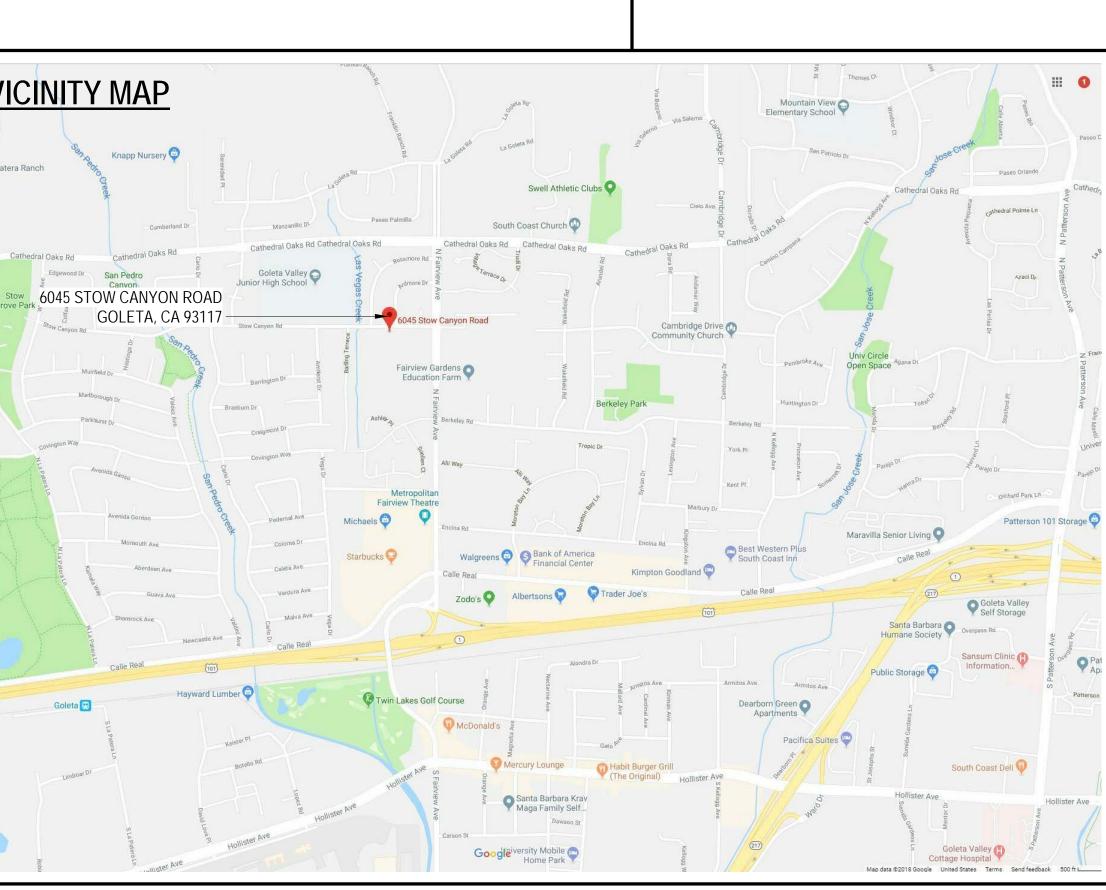
C-3 PRELIMINARY GRADING & DRAINAGE PLAN

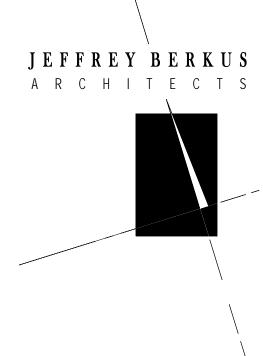
C-4 PRELIMINARY UTILITY PLAN

LANDSCAPE_

L-1 CONCEPTUAL PLANTING PLAN

L-1 IRRIGATION SCHEMATIC PLAN





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03-21-2018 INITIAL SUBMITTAL - CITY OF GOLETA 11-09-2018 RESUBMITTAL - CITY OF GOLETA

PROJECT NAME

CHABAD OF S. BARBARA

FOR CONSTRUCTION

PROJECT No. 15013

SCALE

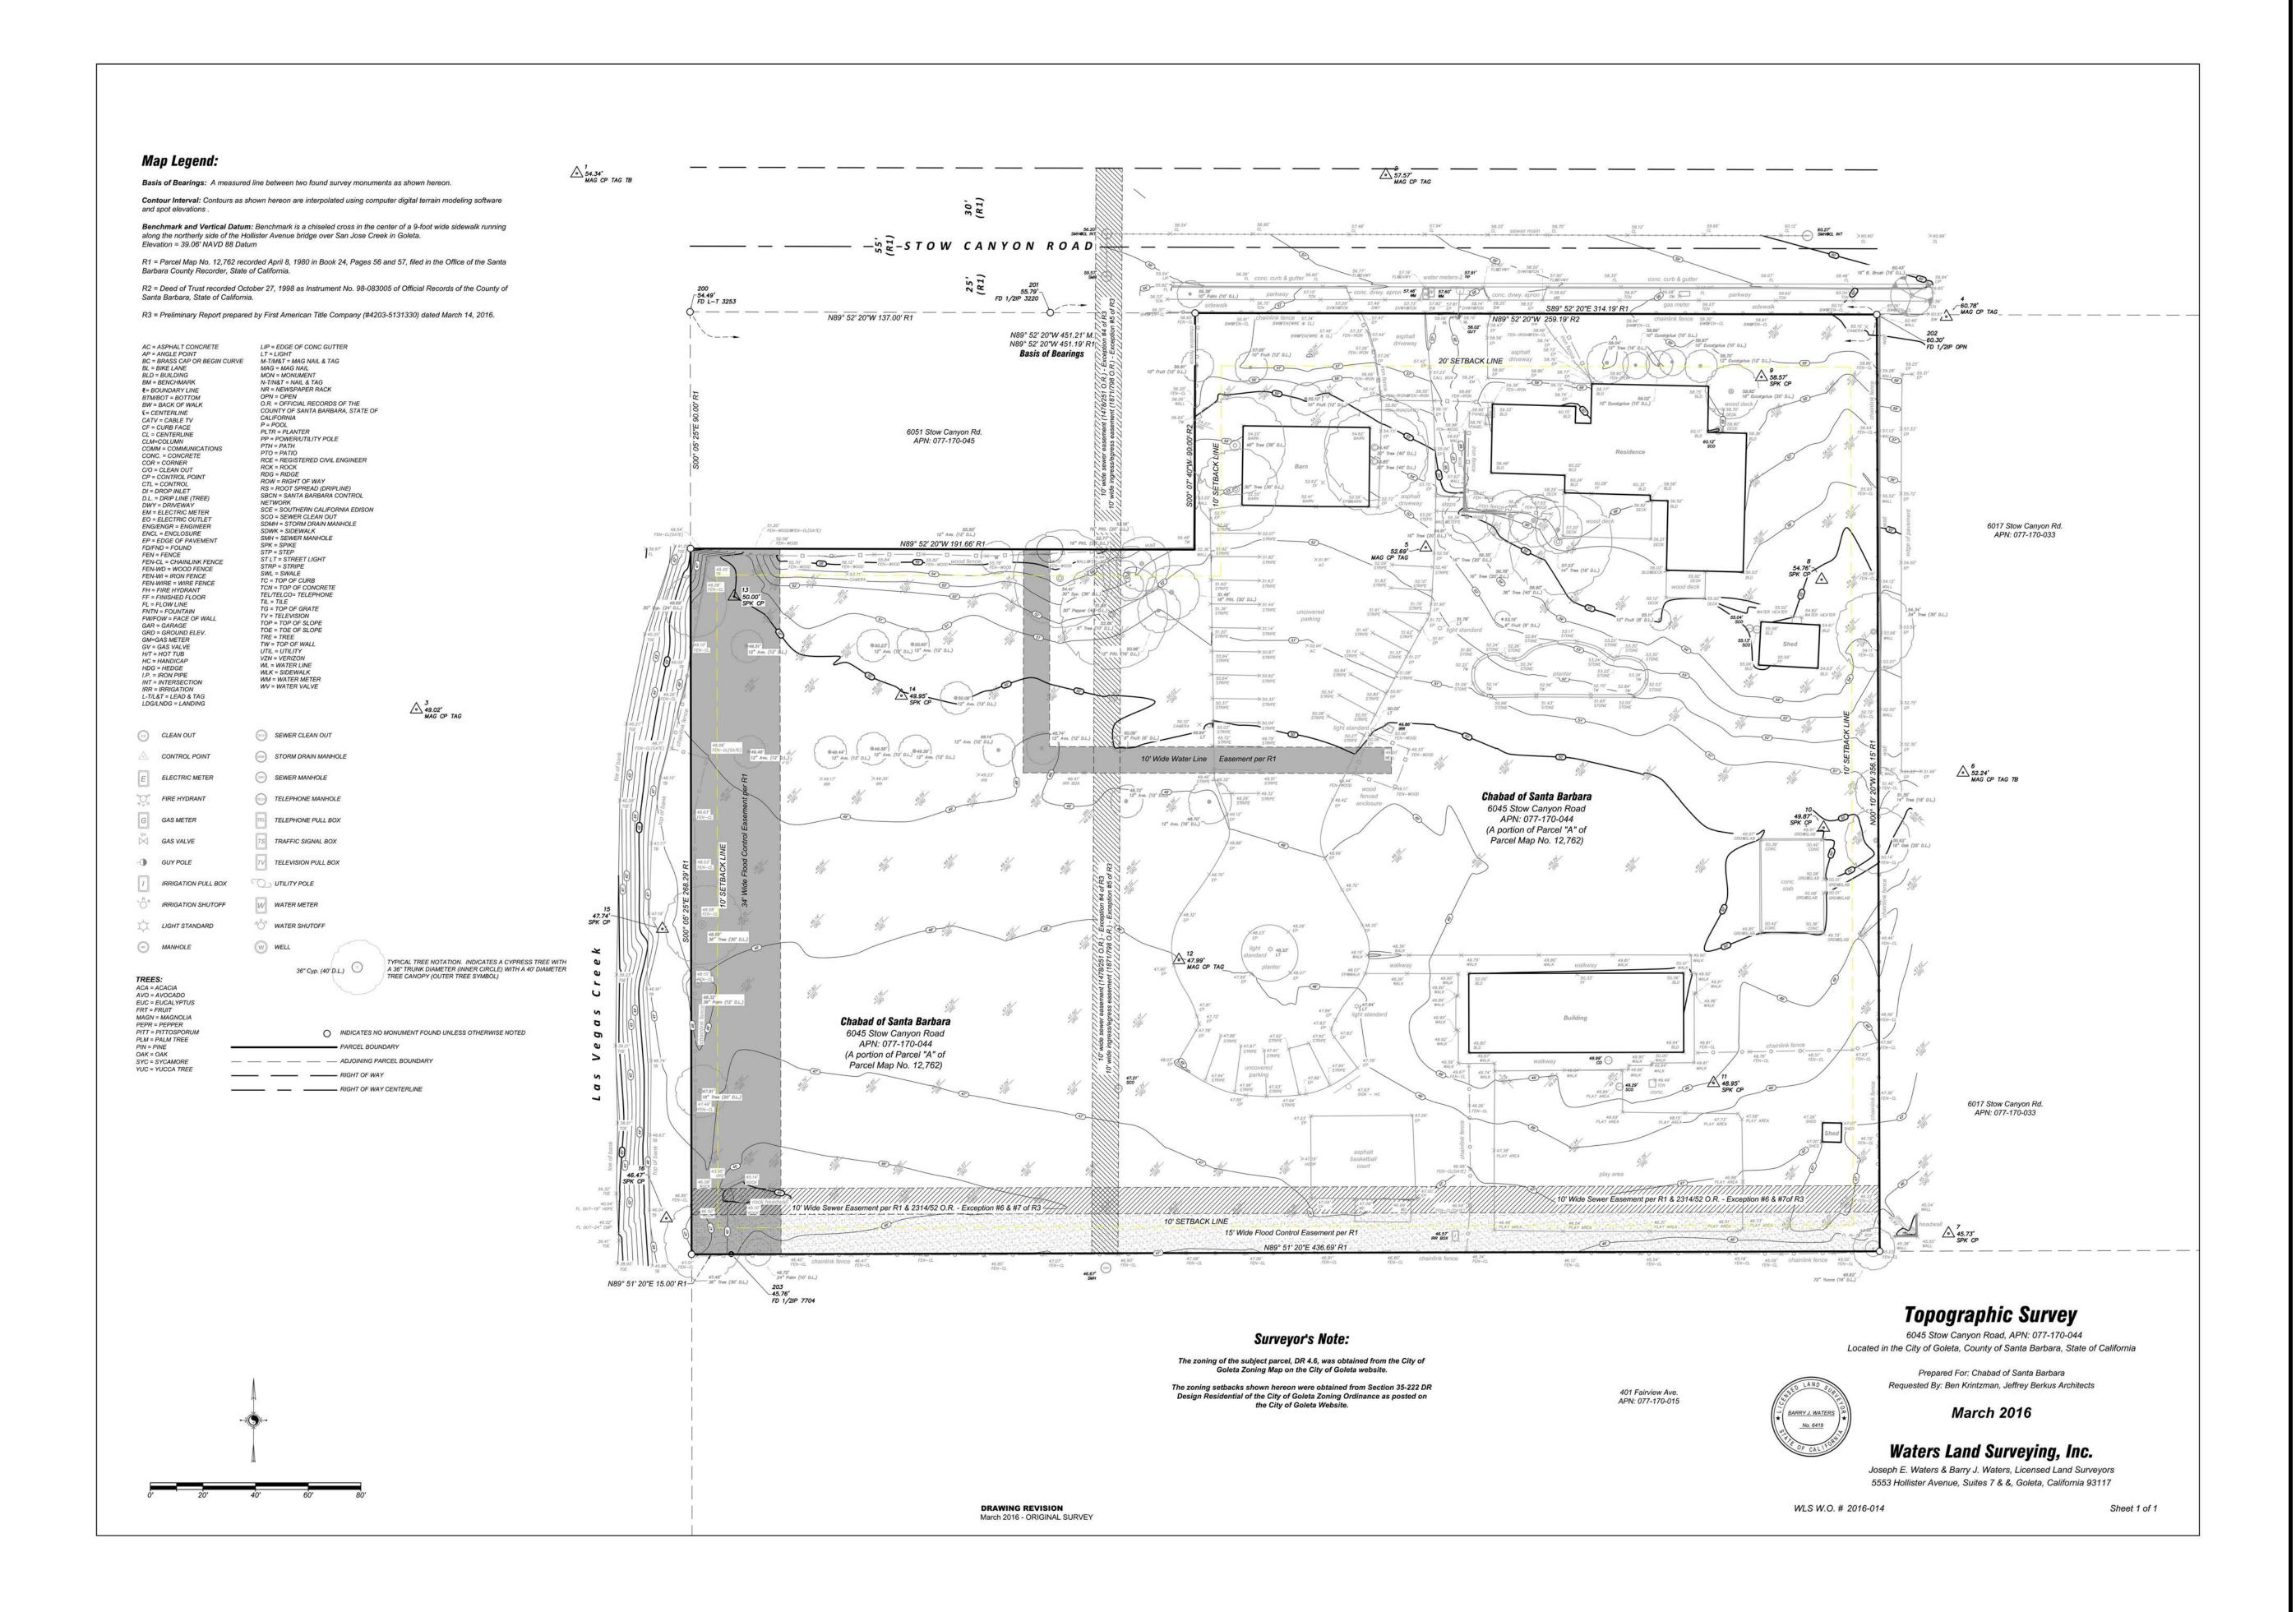
SHEET TITLE

COVER SHEET

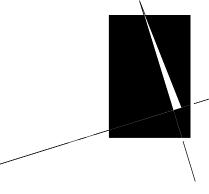
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SANITARY DISTRICT: **GOLETA SANITARY DISTRICT** GOLETA WATER DISTRICT







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PROJECT NAME

CHABAD OF S. BARBARA

FOR CONSTRUCTION

PROJECT No. **15013**

SCALE

1" = 30'-0"

SHEET TITLE

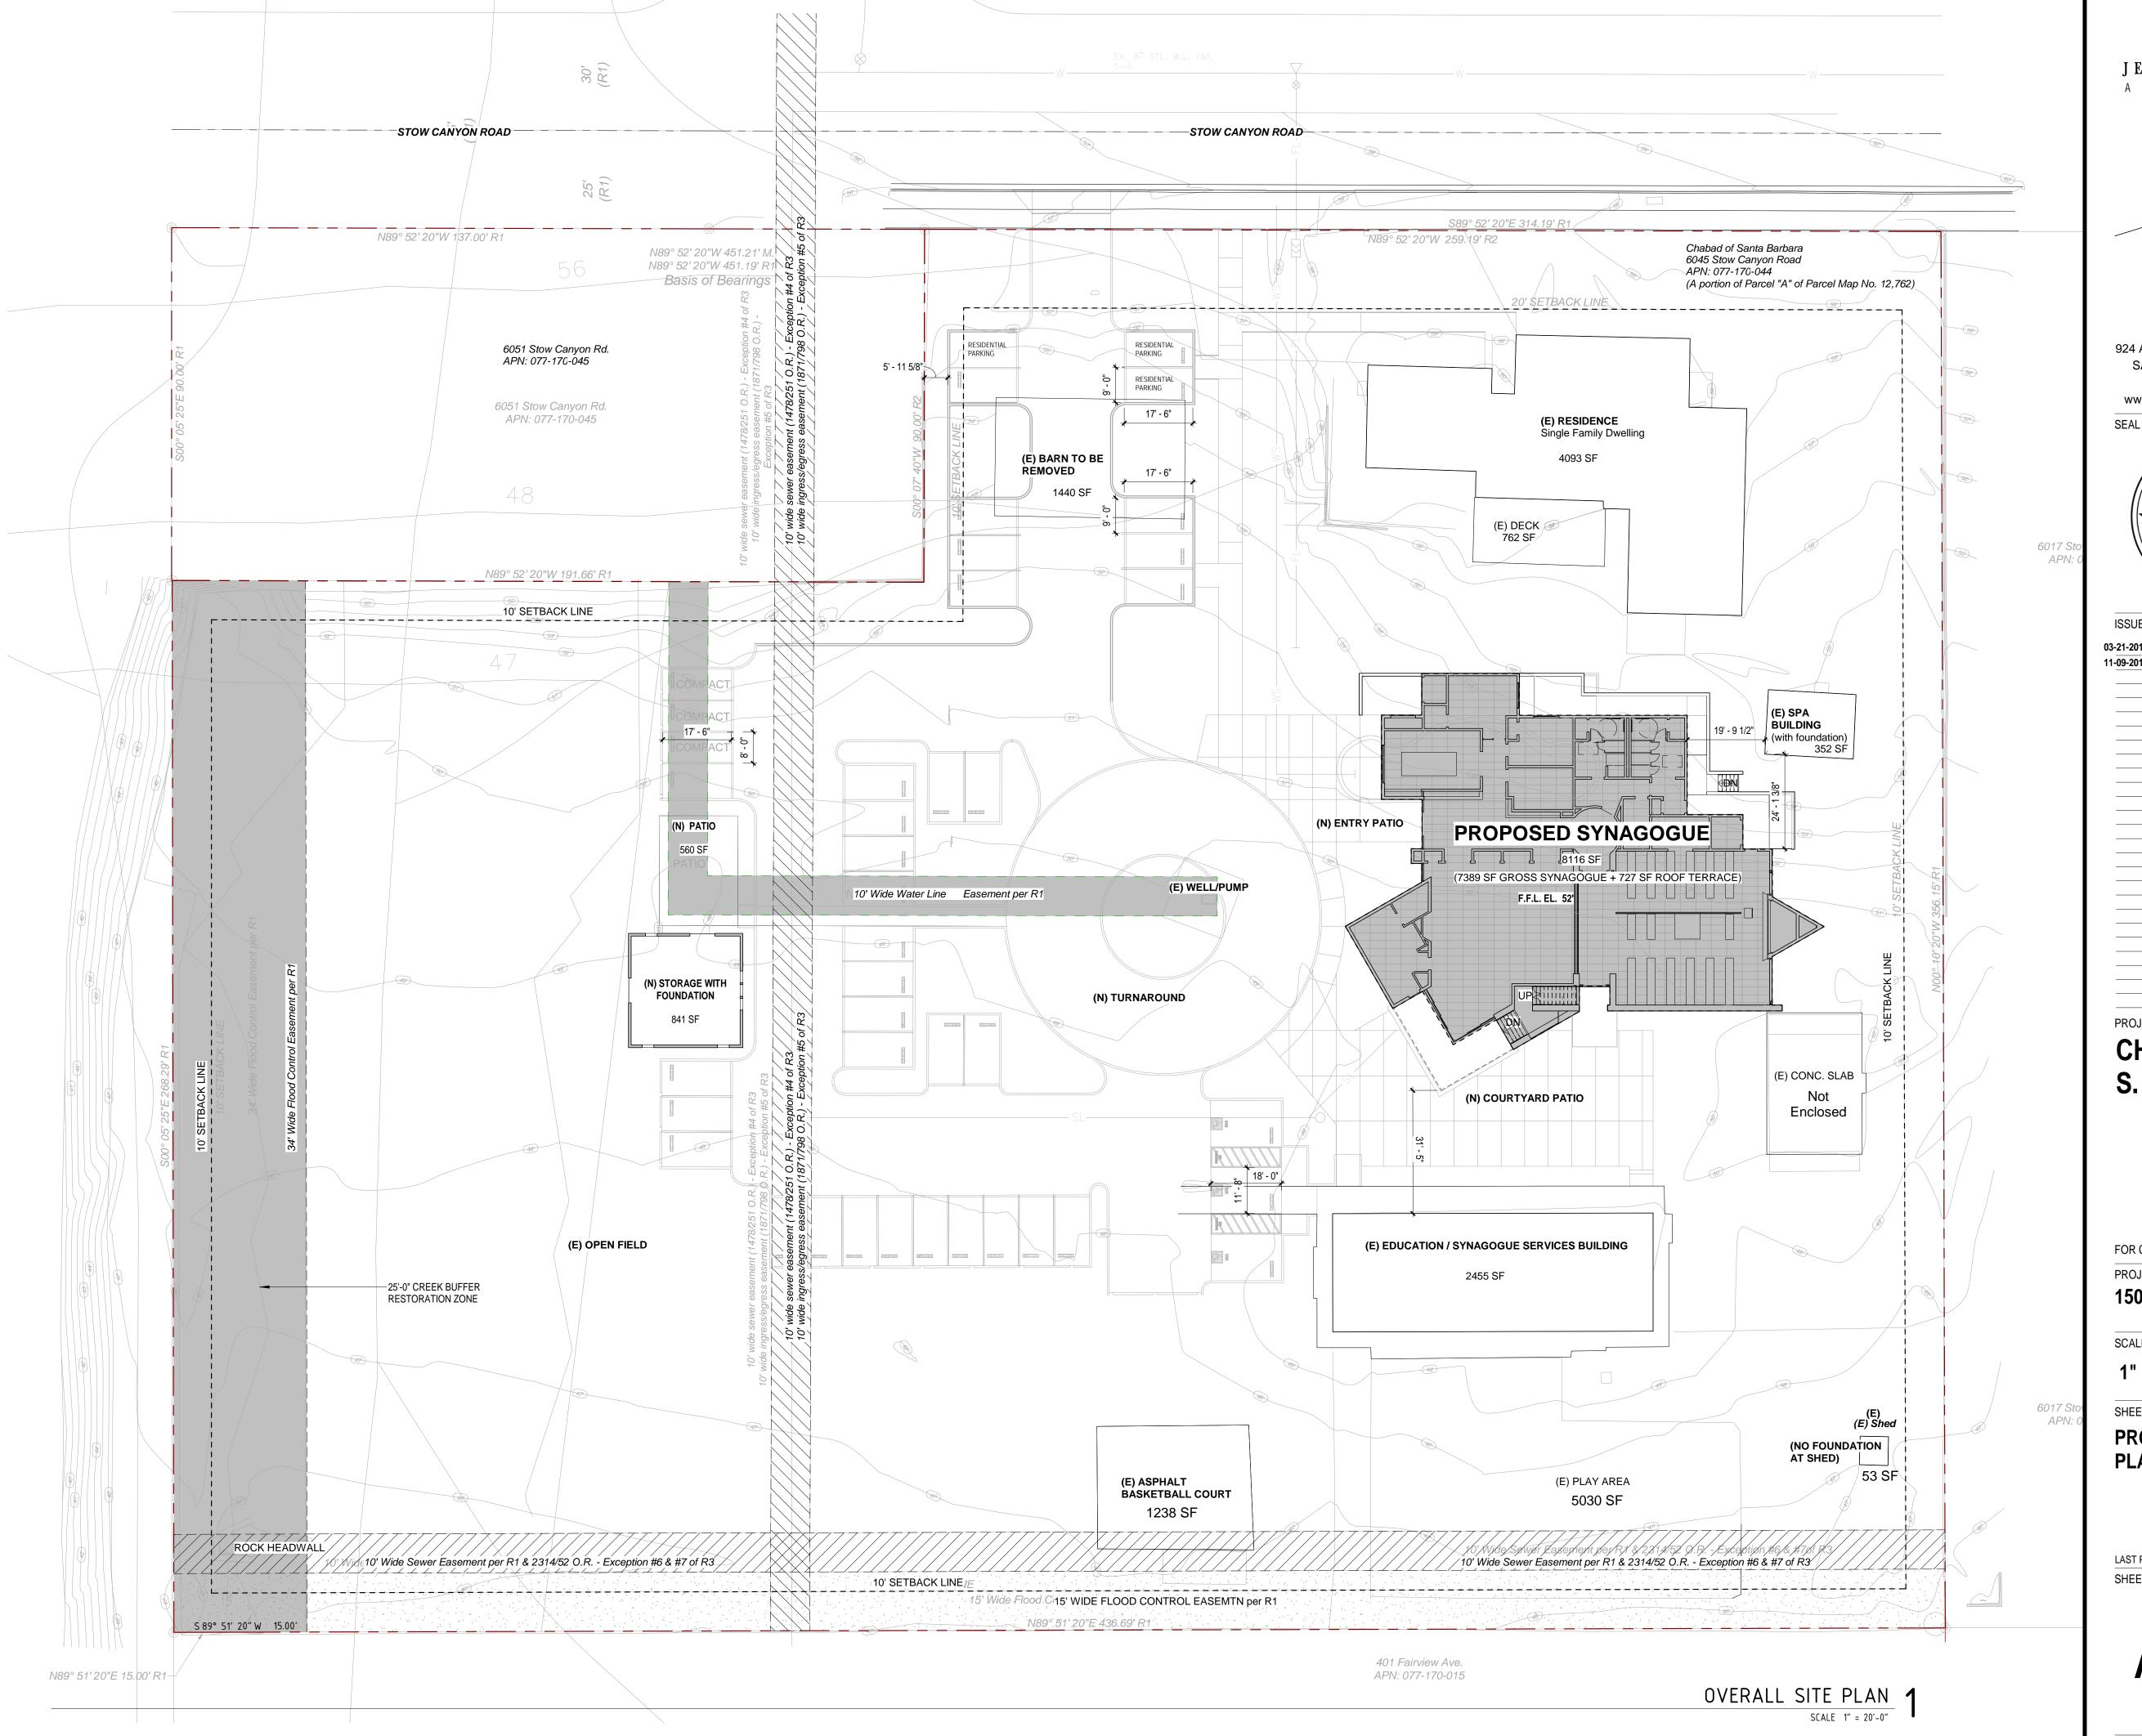
EXISTING SITE PLAN

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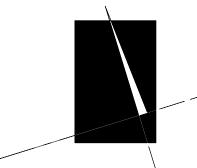
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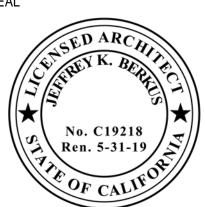
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PROJECT NAME

CHABAD OF S. BARBARA

FOR CONSTRUCTION

PROJECT No. 15013

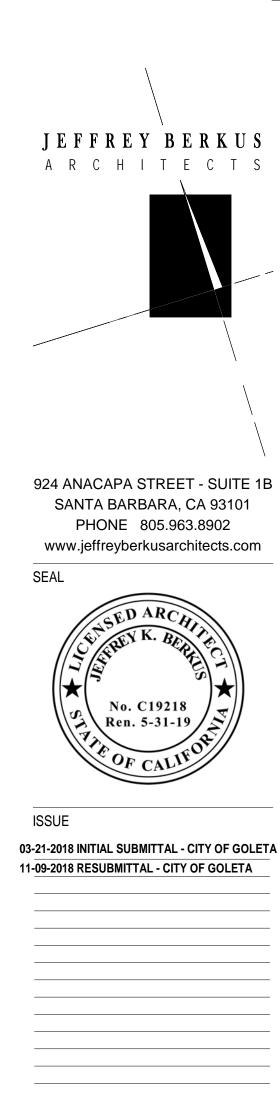
SCALE

1" = 20'-0"

SHEET TITLE

PROPOSED SITE **PLAN**

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CHABAD OF S. BARBARA

FOR CONSTRUCTION

PROJECT No. **15013**

SCALE

3/16" = 1'-0"

SHEET TITLE

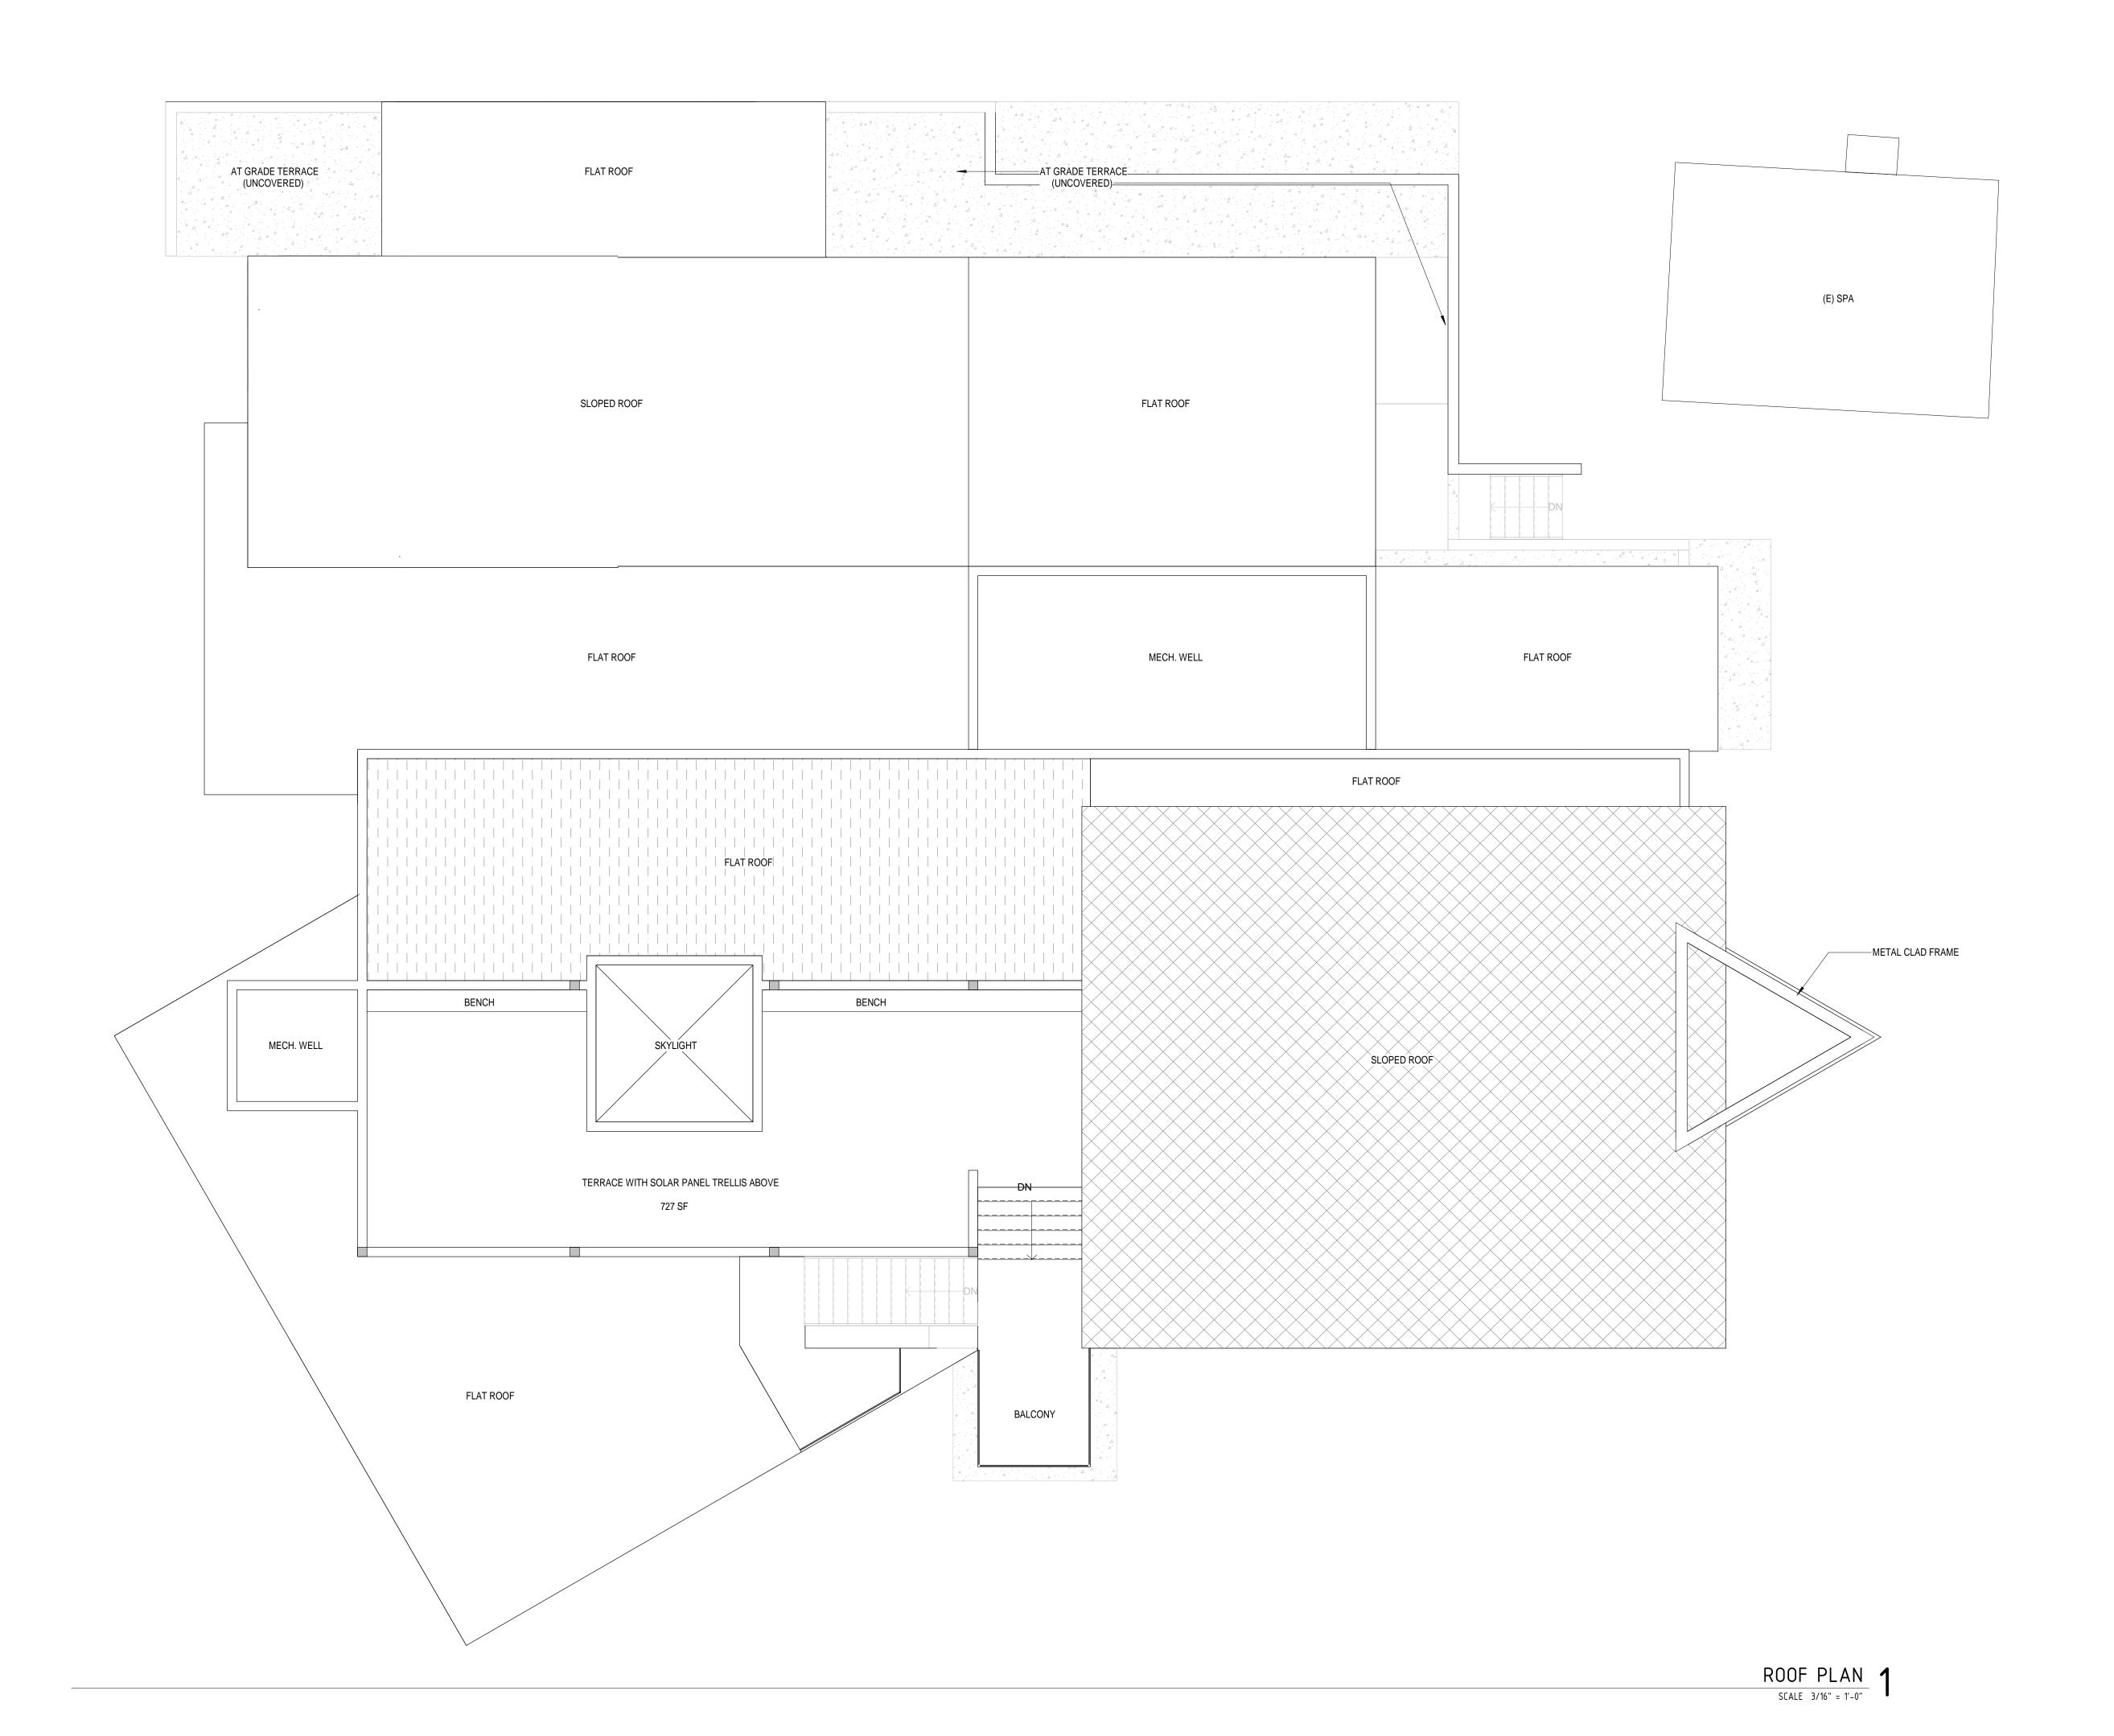
MAIN LEVEL FLOOR PLAN

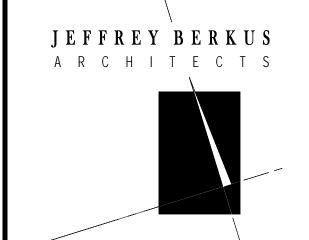
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PROJECT NAME

CHABAD OF S. BARBARA

FOR CONSTRUCTION

PROJECT No. **15013**

SCALE

3/16" = 1'-0"

SHEET TITLE

TERRACE / ROOF

PLAN

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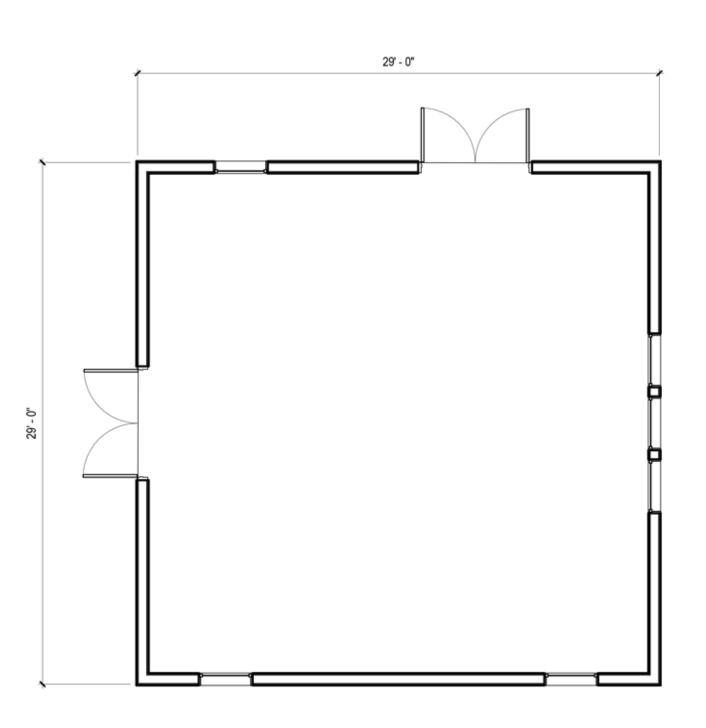
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STORAGE - EAST ELEVATION SCALE 3/16" = 1'-0"

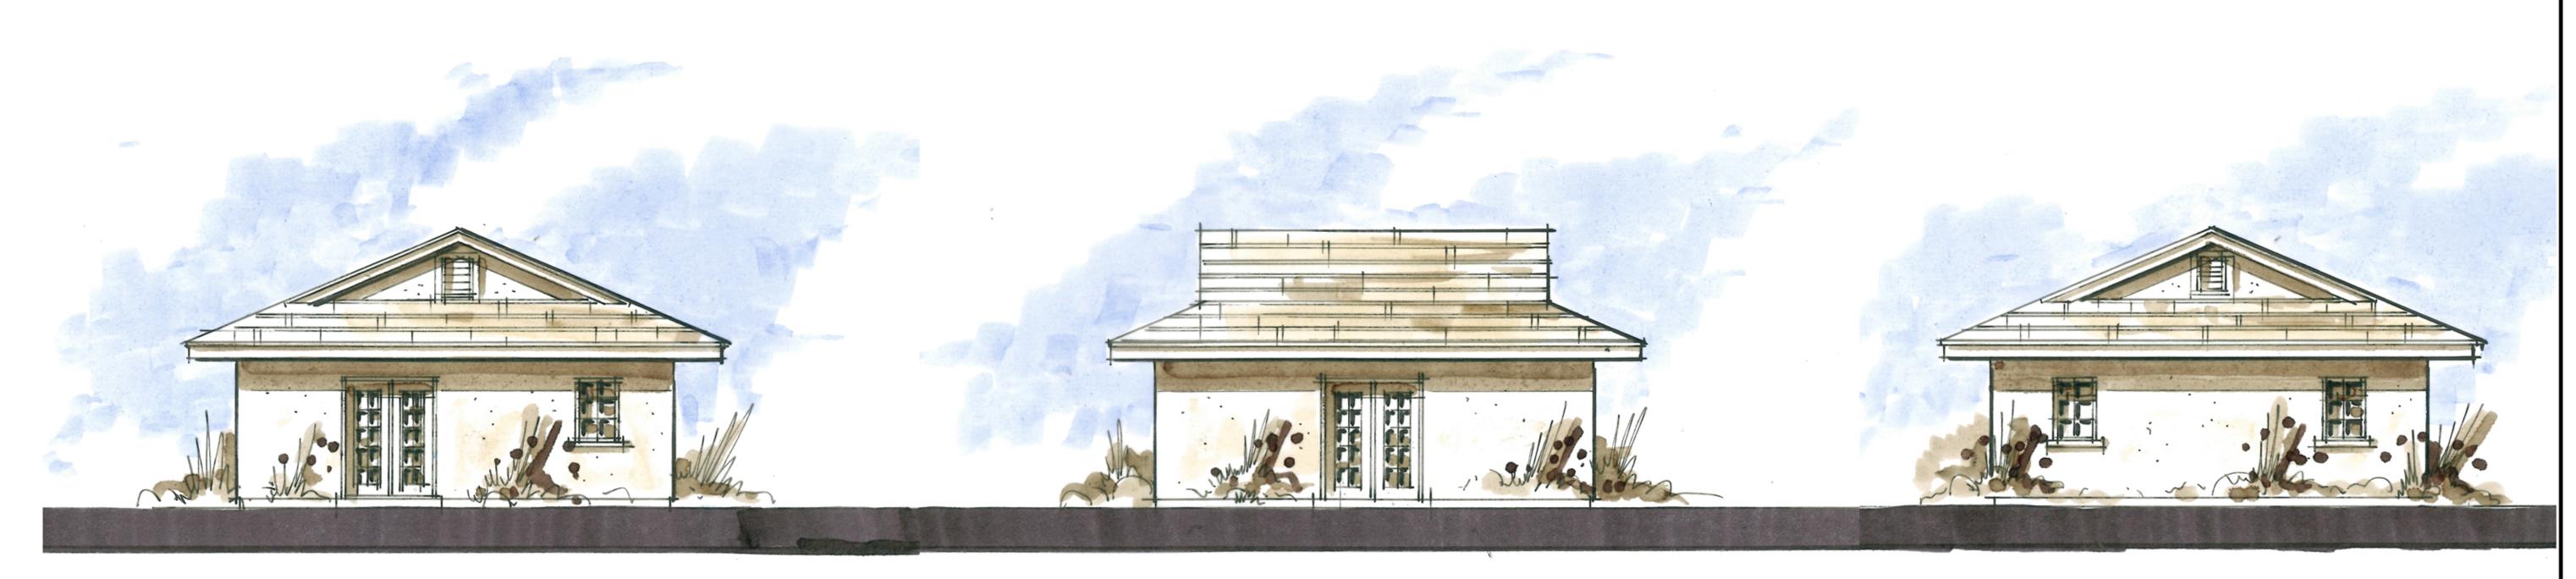
STORAGE - NORTH ELEVATION

SCALE 3/16" = 1'-0"



01 STORAGE SCALE 3/16" = 1'-0"

STORAGE - SOUTH ELEVATION SCALE 3/16" = 1'-0"



STORAGE - WEST ELEVATION

SCALE 3/16" = 1'-0"

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PROJECT NAME CHABAD OF S. BARBARA

FOR CONSTRUCTION

PROJECT No. 15013

SCALE

3/16" = 1'-0"

SHEET TITLE

STORAGE PLAN & **ELEVATIONS**

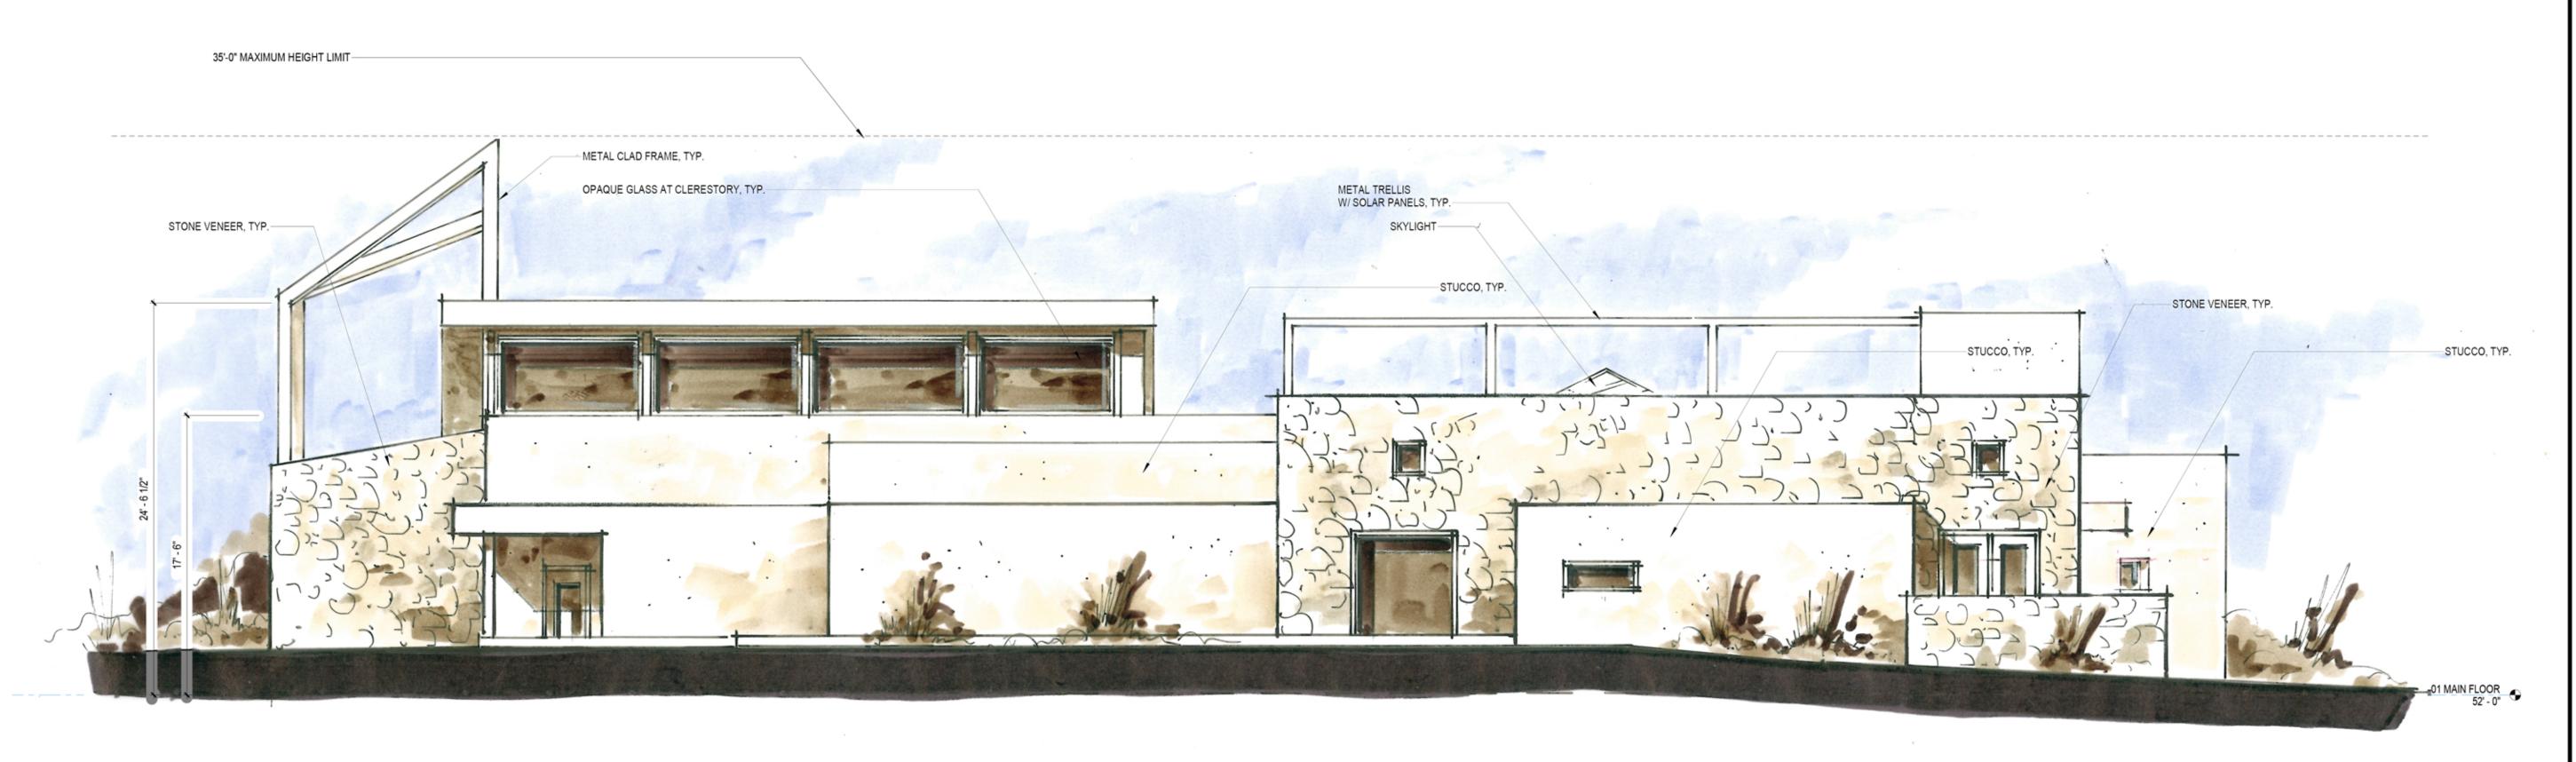
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SOUTH ELEVATION

SCALE 3/16" = 1'-0"

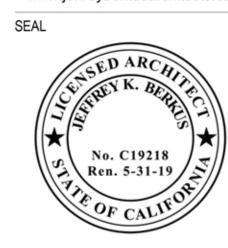


NORTH ELEVATION SCALE 3/16" = 1'-0"

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PROJECT NAME

CHABAD OF S. BARBARA

FOR CONSTRUCTION

PROJECT No. **15013**

SCALE

SHEET TITLE

3/16" = 1'-0"

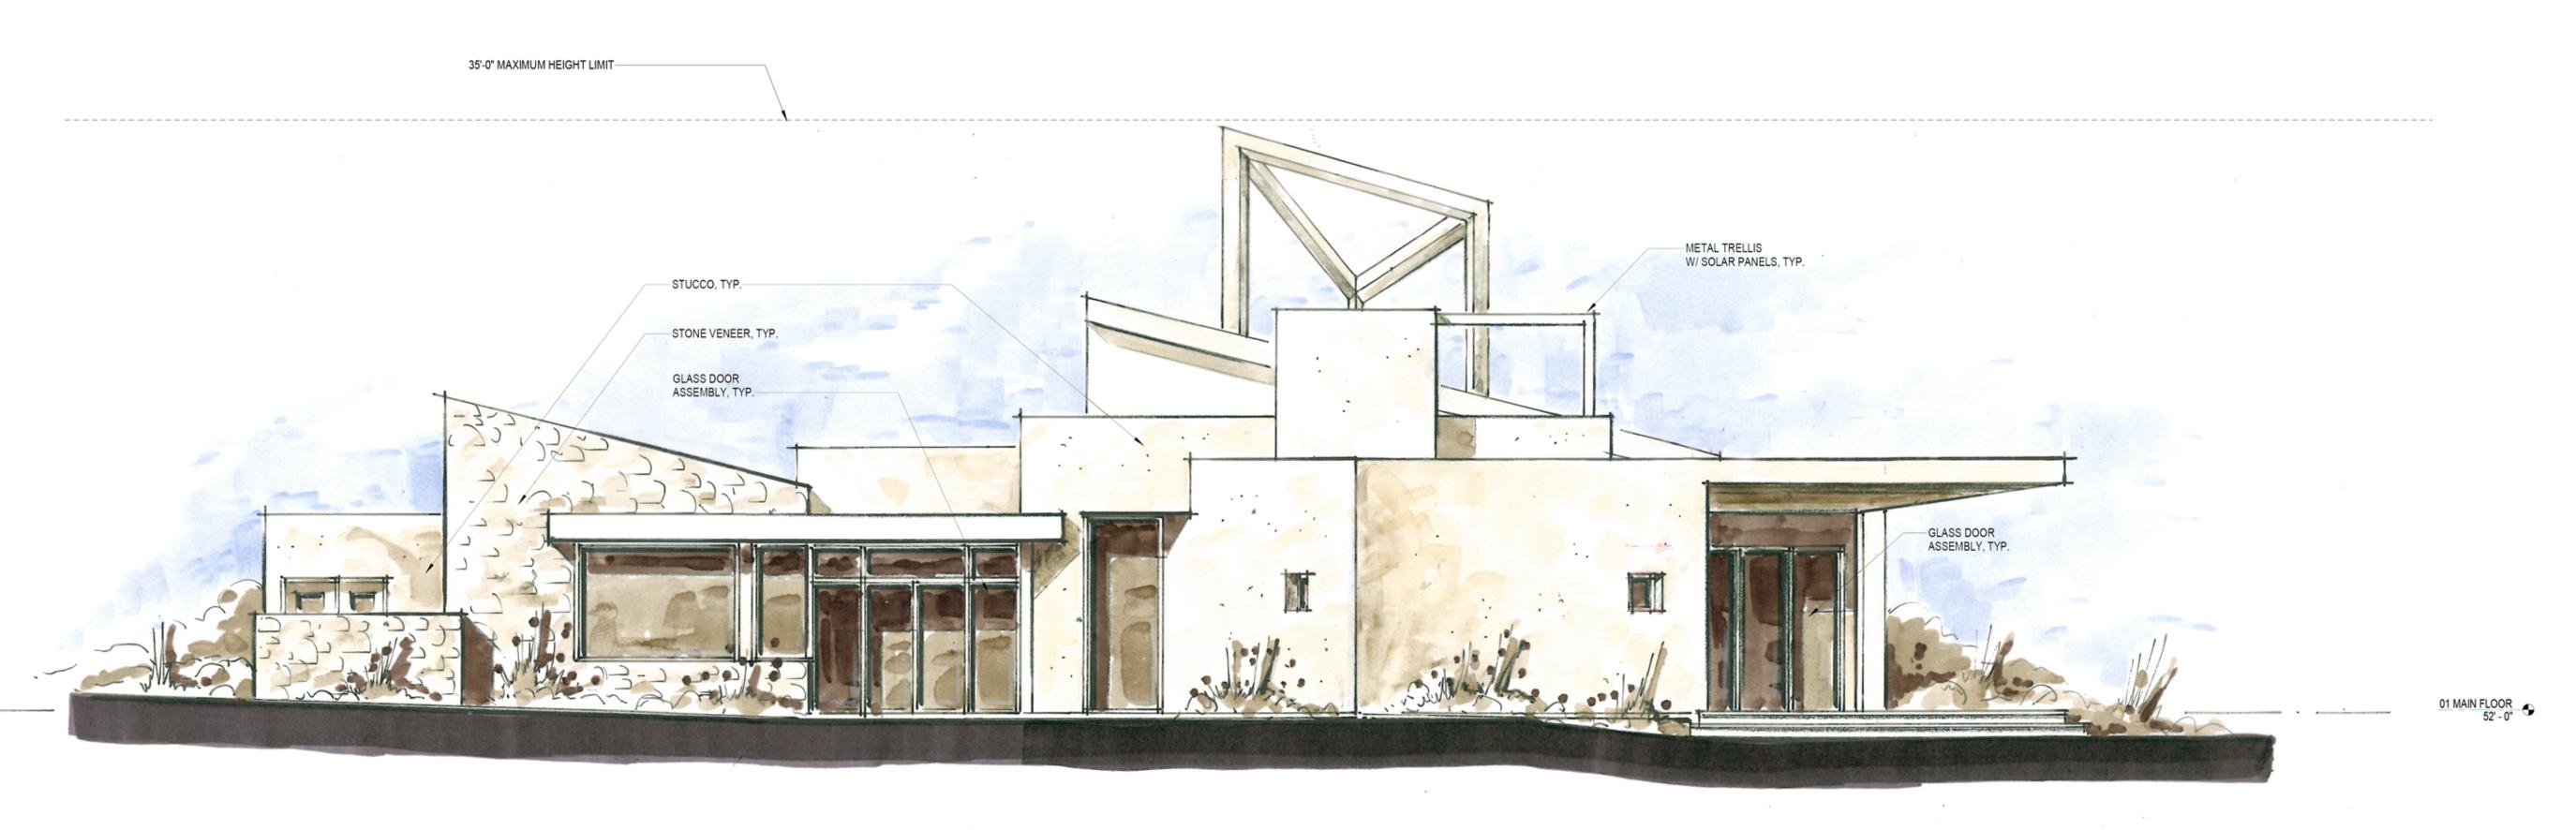
NORTH & SOUTH ELEVATIONS

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A3.01

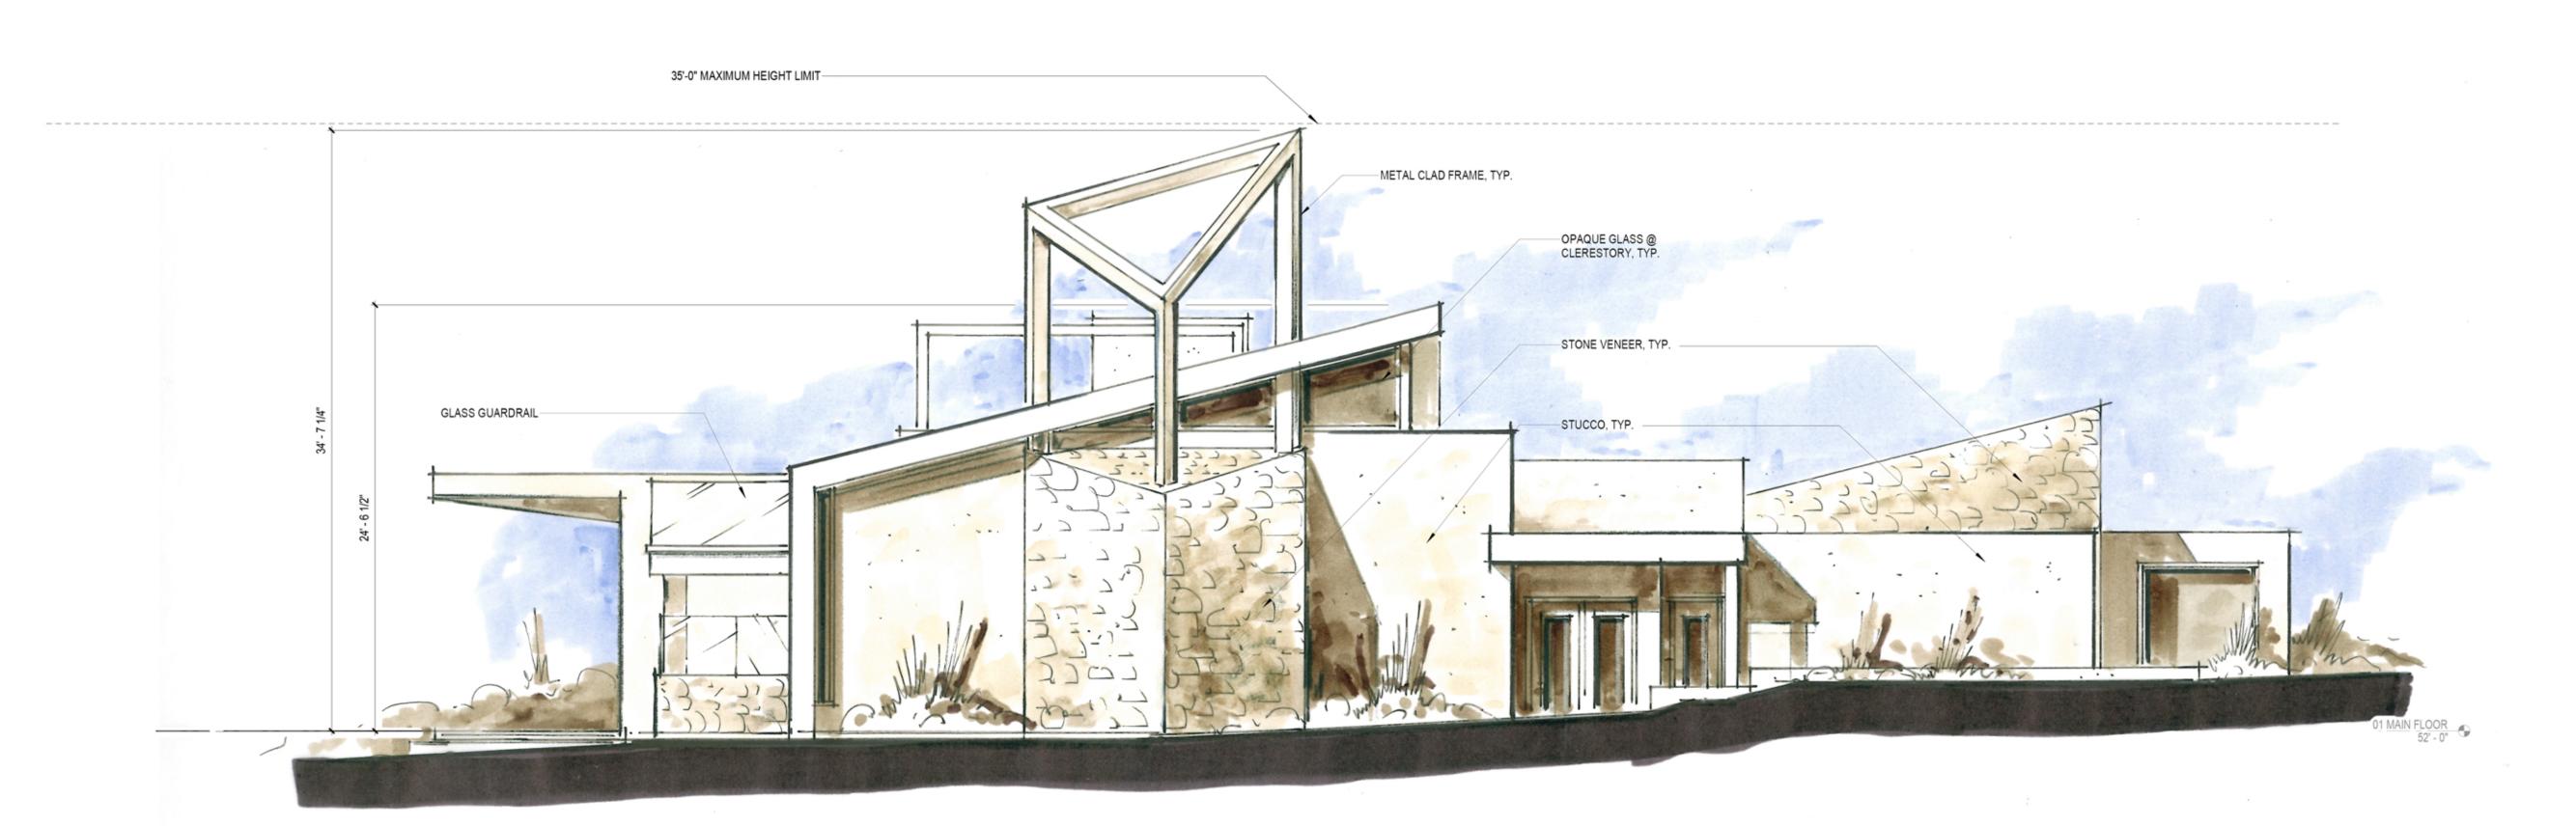
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WEST ELEVATION

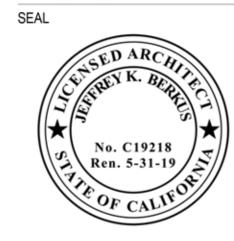
SCALE 3/16" = 1'-0"



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CHABAD OF S. BARBARA

FOR CONSTRUCTION

PROJECT No. **15013**

SCALE

3/16" = 1'-0"

SHEET TITLE

EAST & WEST

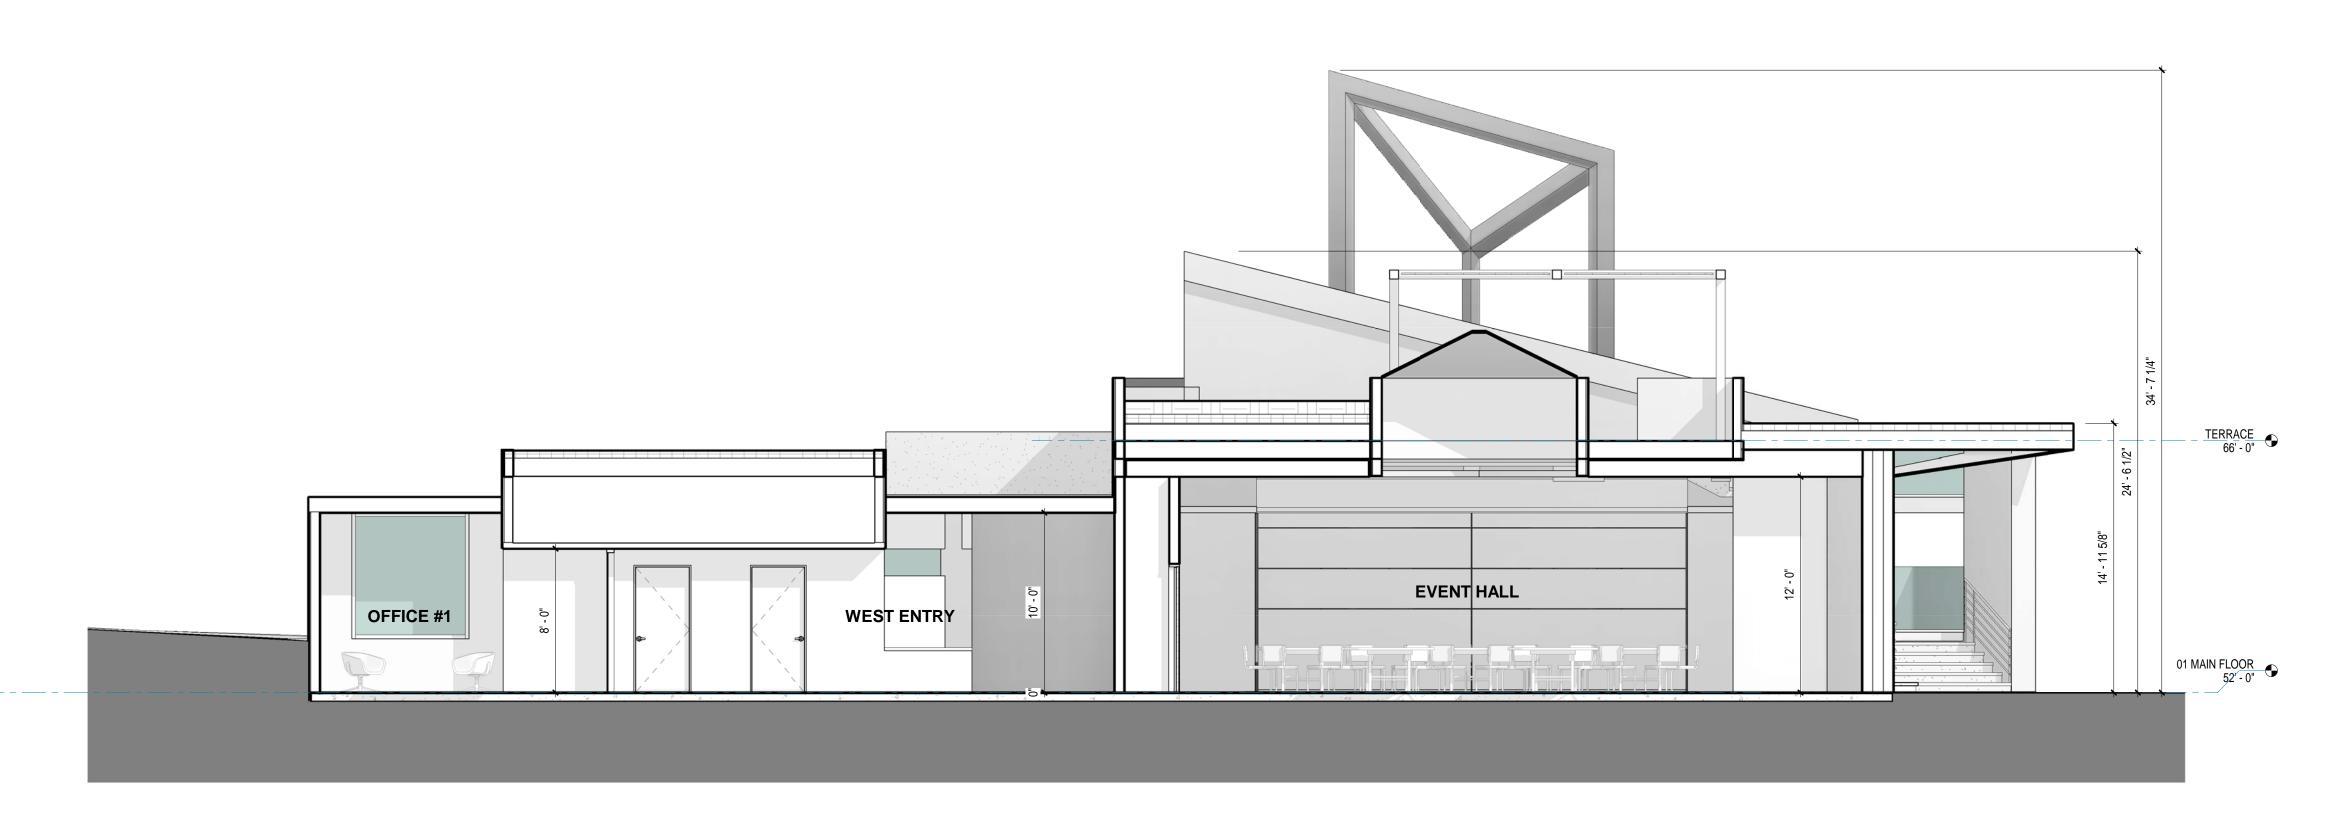
ELEVATIONS

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A3.02

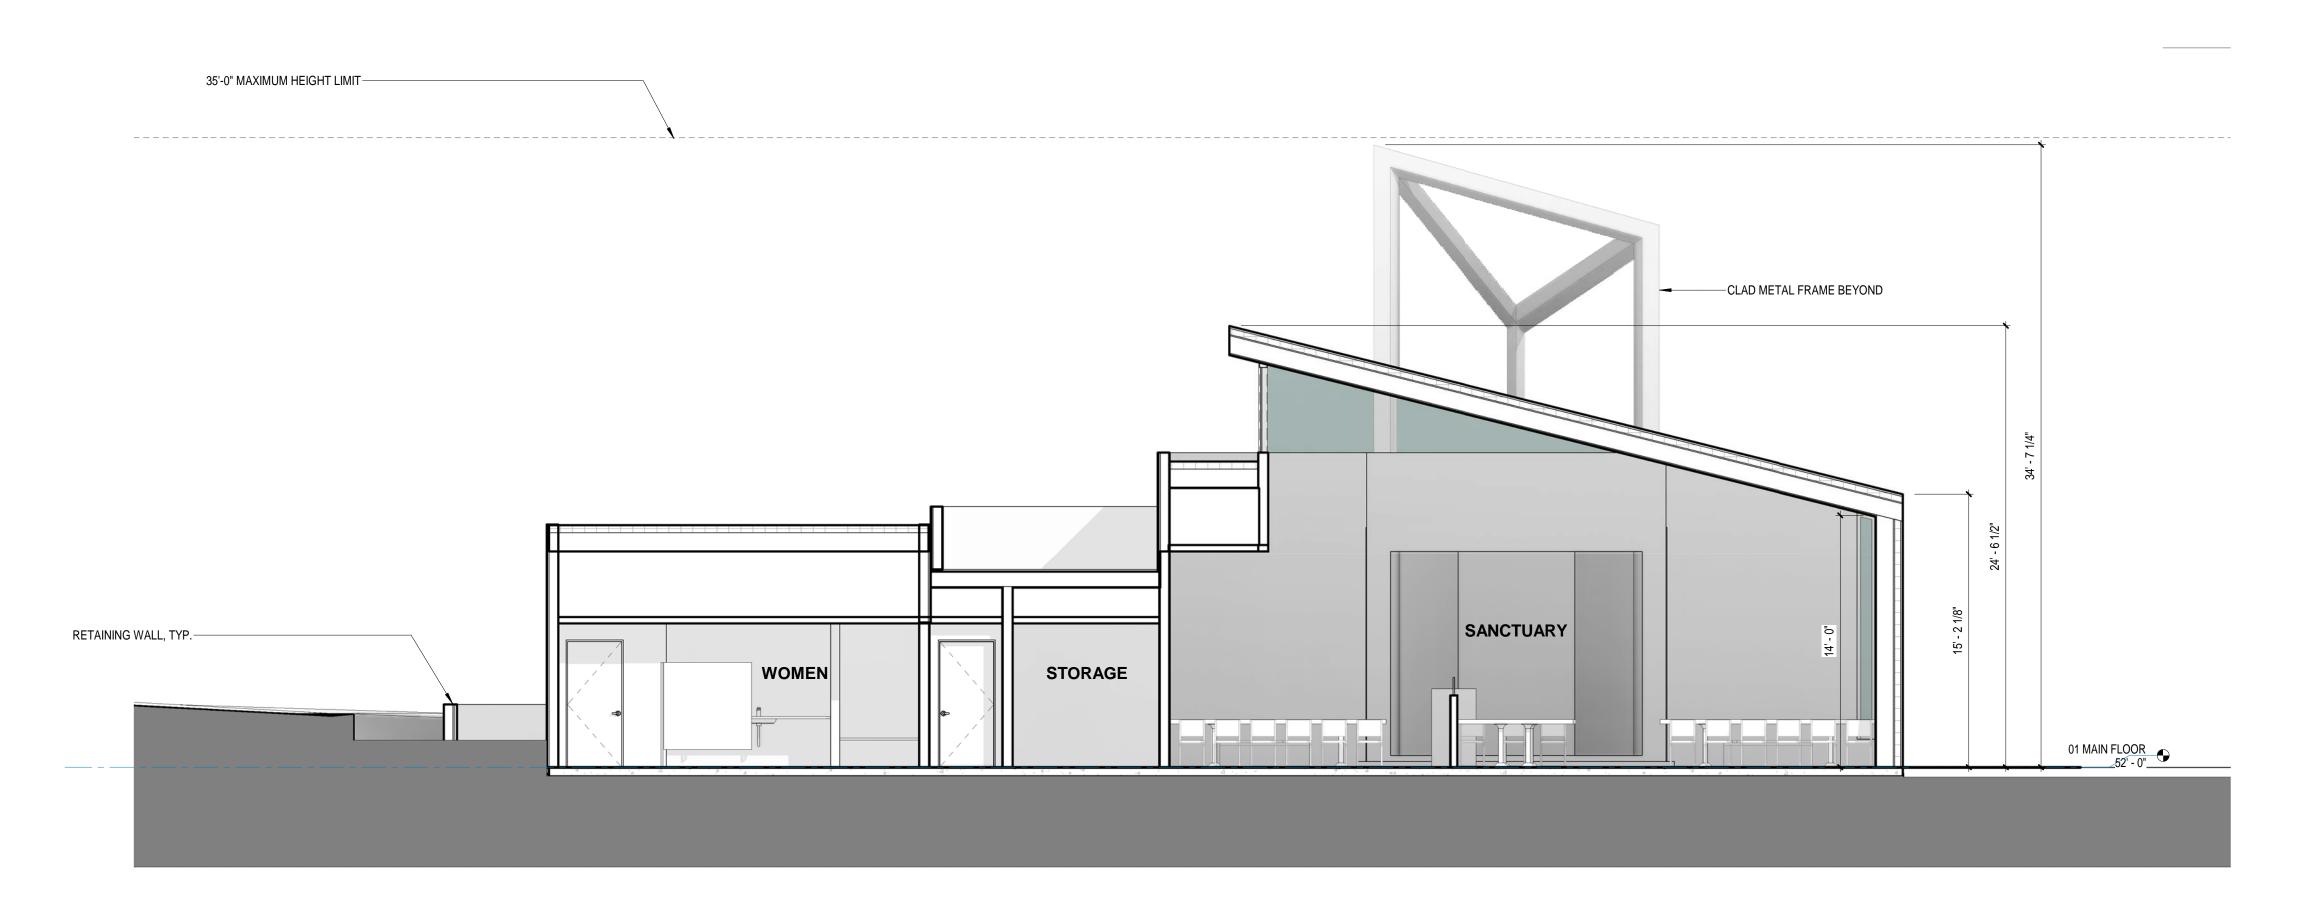
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Section 2

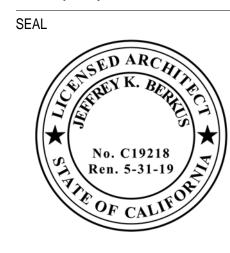
SCALE 3/16" = 1'-0"



Section 4 2

JEFFREY BERKUS
ARCHITECTS

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CHABAD OF S. BARBARA

FOR CONSTRUCTION

PROJECT No. **15013**

SCALE

SHEET TITLE

3/16" = 1'-0"

BUILDING / PARTIAL SITE SECTION

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A4.01

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- GRADING SHALL BE IN CONFORMANCE WITH THESE PLANS AND 4477 AND THE STANDARDS AND REQUIREMENTS PERTAINING
- . GRADING SHALL BE IN CONFORMANCE WITH THE SITE SPECIFIC GRADING RECOMMENDATIONS AND STANDARD GRADING SPECIFICATIONS CONTAINED IN THE GEOTECHNICAL REPORT AND THOSE CONTAINED IN THE GEOLOGY REPORT REFERENCED IN THE GENERAL NOTES ON THESE PLANS.
- GRADING SHALL ALSO BE IN CONFORMANCE WITH RECOMMENDATIONS MADE BY THE GEOTECHNICAL ENGINEER AND THE GEOLOGIST DURING OBSERVATION AND TESTING OF SITE DEMOLITION, PREPARATION, GRADING, AND DEVELOPMENT WORK.
- FOR ANY CONFLICT BETWEEN THESE PLANS AND THE RECOMMENDATIONS AND OR SPECIFICATIONS OF THE GEOTECHNICAL ENGINEER AND THE GEOLOGIST. THE MORE STRINGENT PROVISION SHALL GOVERN.
- . CONTRACTOR SHALL EMPLOY ALL LABOR, EQUIPMENT AND METHODS REQUIRED TO PREVENT HIS OPERATIONS FROM PRODUCING DUST IN AMOUNTS DAMAGING TO PROPERTY CULTIVATED VEGETATION AND DOMESTIC ANIMALS OR CAUSING A HAZARD TO VEHICULAR TRAFFIC OR CAUSING A NUISANCE TO PERSONS OCCUPYING BUILDINGS, IN THE VICINITY OF THE JOB SITE. CONTRACTOR SHALL BE RESPONSIBLE FOR ANY DAMAGE CAUSED BY DUST RESULTING FROM HIS OPERATIONS. DUST ABATEMENT MEASURES SHALL BE CONTINUED UNTIL RELIEF IS GRANTED BY THE CITY INSPECTOR.
- 4. AREAS TO BE GRADED SHALL BE CLEARED OF ALL VEGETATION (EXCEPT TREES INDICATED TO REMAIN), INCLUDING ROOTS AND ROOT STRUCTURES, OTHER ORGANIC MATERIAL. DEBRIS, NON-COMPLYING FILL, AND OTHER MATERIAL UNSUITABLE FOR SUPPORT OF FILL AND/OR PROPOSED IMPROVEMENTS, AS RECOMMENDED BY AND UNDER THE OBSERVATION AND TESTING OF THE GEOTECHNICAL ENGINEER.
- 5. THE CONTRACTOR SHALL MAKE A THOROUGH SEARCH FOR ALL ABANDONED MAN-MADE FACILITIES SUCH AS SEPTIC TANK SYSTEMS, FUEL OR WATER STORAGE TANKS, AND PIPELINES OR CONDUITS. ANY SUCH FACILITIES ENCOUNTERED SHALL BE REMOVED AND THE VOIDS FILLED AND COMPACTED AS RECOMMENDED BY, AND UNDER THE OBSERVATION AND TESTING OF, THE GEOTECHNICAL ENGINEER AND THE CITY OF GOLETA.
- VOIDS LEFT FROM OTHER REMOVALS, SUCH AS TREES AND STRUCTURES, SHALL ALSO BE FILLED AND COMPACTED AS RECOMMENDED BY, AND UNDER THE OBSERVATION AND TESTING OF, THE GEOTECHNICAL ENGINEER AND THE CITY OF GOLETA.
- IF ABANDONED SEPTIC TANKS OR FUEL TANKS OR OTHER POTENTIAL SOURCES OF CONTAMINATION OR HAZARDOUS WASTE ARE ENCOUNTERED OR IF SOIL WHICH APPEARS TO BE CONTAMINATED IS ENCOUNTERED, CONTRACTOR SHALL IMMEDIATELY NOTIFY OWNER AND COUNTY HAZARDOUS MATERIALS OFFICE.
- ABANDONED PIPELINES AND CONDUITS SHALL BE REMOVED UNLESS OTHERWISE ALLOWED BY THE PROJECT ENGINEER, THE GEOTECHNICAL ENGINEER AND THE CITY OF GOLETA. PIPELINES OR CONDUITS ALLOWED TO BE ABANDONED-IN-PLACE SHALL BE CRUSHED OR SHALL HAVE ALL EXPOSED OPENINGS PLUGGED WITH STIFF CONCRETE RODDED TO REMOVE VOIDS WITHIN THE PIPELINE/CONDUIT TO A MINIMUM OF 5 LINEAL FEET BEYOND THE OPENING, UNDER THE OBSERVATION OF THE GEOTECHNICAL ENGINEER AND THE CITY OF GOLETA.
- UNDOCUMENTED FILL AND/OR UNSTABLE SOILS ENCOUNTERED DURING GRADING SHALL BE EXCAVATED TO FIRM NATIVE SOILS UNDER THE OBSERVATION AND TESTING OF THE GEOTECHNICAL ENGINEER AND THE CITY OF GOLETA.
- OVERWET AND/OR PUMPING AREAS ENCOUNTERED DURING GRADING SHALL BE REVIEWED FOR CORRECTIVE MEASURES BY THE GEOTECHNICAL ENGINEER AND THE CITY OF GOLETA.
- 7. ALL UNSUITABLE SOIL MATERIALS AND RUBBISH AND DEBRIS RESULTING FROM DEMOLITION AND GRADING OPERATIONS SHALL BE REMOVED FROM THE JOB SITE, BE TRANSPORTED TO A SUITABLE LOCATION, AND BE DISPOSED OF IN A PROPER AND LEGAL MANNER.
- 8. AREAS TO RECEIVE FILL MATERIAL AND AREAS TO RECEIVE WALKWAYS, PAVEMENT AND OTHER STRUCTURAL IMPROVEMENTS SHALL BE PREPARED AS RECOMMENDED BY. AND UNDER THE OBSERVATION AND TESTING OF, THE GEOTECHNICAL ENGINEER AND THE CITY OF GOLETA. RECOMMENDATIONS FOR OVEREXCAVATION, ADDITIONAL SCARIFICATION, BACKFILL AND RECOMPACTION ARE CONTAINED IN THE GEOTECHNICAL REPORT REFERENCED IN THE GENERAL NOTES ON THESE PLANS.
- 9. PRIOR TO PLACEMENT OF FILL AND BACKFILL MATERIAL, THE PREPARED AREA SHALL BE INSPECTED AND APPROVED BY THE CITY INSPECTOR. THE GEOTECHNICAL ENGINEER SHALL ALSO OBSERVE THE AREAS TO BE FILLED. ALLOW A MINIMUM 48-HOUR NOTICE. FILL AND BACKFILL PLACED ON THE PREPARED AREA WITHOUT THE REQUIRED OBSERVATION SHALL BE REMOVED.
- 10.ALL FILL MATERIAL, WHETHER EXCAVATED ON-SITE OR IMPORTED FROM OFF-SITE, SHALL BE TESTED AND APPROVED BY THE GEOTECHNICAL ENGINEER AND THE CITY OF GOLETA PRIOR TO PLACEMENT.
- IMPORTED FILL MATERIAL SHALL BE EQUAL TO OR BETTER IN QUALITY THAN THE ON-SITE SOILS AND SHALL CONFORM TO THE RECOMMENDATION OF THE GEOTECHNICAL ENGINEER. THE GEOTECHNICAL ENGINEER SHALL TEST AND APPROVE THE SOIL PROPOSED FOR IMPORT FOR STRUCTURAL FILL PRIOR TO IMPORTATION TO THE SITE.
- THE LANDSCAPE ARCHITECT AND THE GEOTECHNICAL ENGINEER SHALL TEST AND APPROVE THE SOIL PROPOSED FOR IMPORT FOR LANDSCAPE AREA SURFACE MATERIAL PRIOR TO IMPORTATION TO THE SITE.
- 11.FILL MATERIAL SHALL BE SPREAD IN LIFTS NOT EXCEEDING 8-INCHES IN LOOSE THICKNESS, BE MOISTENED OR DRIED AS RECOMMENDED BY THE GEOTECHNICAL ENGINEER, AND BE COMPACTED TO THE MINIMUM RELATIVE COMPACTION RECOMMENDED BY THE GEOTECHNICAL ENGINEER. THINNER LIFTS MAY BE NECESSARY TO ACHIEVE THE REQUIRED MINIMUM COMPACTION.
- 12.FILL AND BACKFILL MATERIAL SHALL BE COMPACTED AT LEAST TO THE SPECIFIED RELATIVE COMPACTION BUT IN NO CASE TO LESS THAN 90% OF MAXIMUM DENSITY DETERMINED IN CONFORMANCE WITH A.S.T.M. STANDARD D-1557, LATEST REVISION. SOME AREAS REQUIRE COMPACTION TO GREATER DENSITY AS CALLED FOR ON THESE PLANS OR BY THE GEOTECHNICAL ENGINEER.

REFERENCES:

DRAWING FILE:

PROJECT FILE:

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COMPACTION TESTS SHALL BE CONDUCTED AS DETERMINED BY THE GEOTECHNICAL ENGINEER AND AT NOT LESS THAN ONE (1) TEST FOR EACH 2,500 SQUARE FEET OF FILL PLACED UNDER PAVEMENT AREAS AND AT NOT LESS THAN ONE (1) TEST FOR EACH 10,000 SQUARE FEET OF FILL PLACED OUTSIDE PAVEMENT AREAS, WITH THESE TESTS BEING CONDUCTED AT LEAST FOR EACH LIFT VERTICALLY AS THE FILL IS PLACED.

REVISIONS

GRADING NOTES

- 13.FINISH CUT SLOPES, FILL SLOPES AND COMBINATION CUT AND FILL SLOPES SHALL NOT EXCEED A GRADE OF 2 HORIZONTAL TO 1 VERTICAL UNLESS SPECIFICALLY CALLED FOR ON THESE PLANS AND CONSTRUCTED AS RECOMMENDED BY THE GEOTECHNICAL ENGINEER AND THE ENGINEERING GEOLOGIST.
- 14.ALL SLOPES OVER 3 FEET HIGH SHALL BE PLANTED WITH A NATIVE SEED MIX APPROVED BY THE CITY PLANNING AND DEVELOPMENT DEPARTMENT AND SHALL BE DENSE AND GROWING PRIOR TO FINAL INSPECTION BY THE CITY.
- 15.CONTRACTOR SHALL REFER TO STREET IMPROVEMENT PLANS FOR INTERFACING WITH PUBLIC GRADING, PAVING AND STORM DRAINAGE IMPROVEMENTS.
- 16.IF NOT DIMENSIONED, LOCATION OF FINISH GRADE ELEVATIONS AND FEATURES SUCH AS SWALES, RIDGE LINES, ETC. SHALL BE DETERMINED BY SCALE FROM KNOWN POINTS SHOWN ON THE PLANS. UNIFORM GRADIENTS OR VERTICAL CURVES, AS APPROPRIATE, SHALL BE ASSUMED BETWEEN CONTROL ELEVATIONS SHOWN ON THE PLANS.
- 17.SURFACE DRAINAGE GRADIENT ON SOIL OR LANDSCAPED AREAS SHALL NOT BE AT LESS THAN 2% ($\frac{1}{4}$ " PER FOOT).
- 18.PLAN ELEVATIONS SHOWN ON WALKWAYS, RAMPS, STEPS AND OTHER HARDSCAPE ARE INTENDED TO ESTABLISH GRADING AND SURFACE DRAINAGE CONTROL FOR THESE IMPROVEMENTS. THESE CONTROL ELEVATIONS SHALL BE ADHERED TO UNLESS OTHERWISE NECESSARY FOR CONSTRUCTION OF THESE IMPROVEMENTS IN CONFORMANCE WITH BUILDING CODE AND A.D.A. REQUIREMENTS. IT SHALL BE CONTRACTOR'S RESPONSIBILITY TO PERFORM DETAILED LAYOUT FOR AND TO CONSTRUCT WALKWAYS, RAMPS, STEPS, AND OTHER HARDSCAPE IN CONFORMANCE WITH ALL BUILDING CODE AND ACCESSIBILITY REQUIREMENTS INCLUDING THOSE FOR DIMENSIONING, SLOPE, CROSS-SLOPE, SURFACE TEXTURE, WARNING CURBS, AND HAND-RAILS.
- 19.DROP-OFF FROM TOP OF WALK OR FLATWORK EDGE TO ADJACENT FINISH GRADE SHALL NOT EXCEED 3 INCHES UNLESS A 6-INCH HIGH WARNING CURB IS CONSTRUCTED ALONG THE EDGE AND THE EDGE IS THICKENED (DEEPENED) TO 6-INCHES MINIMUM BELOW ADJACENT FINISH GRADE.
- 20.SITE FINISH GRADING SHALL BE COMPLETED AND CONFIRMED BY SURVEY TO CONFORM TO APPROVED PLANS AND SPECIFICATIONS.
- 21.PAVEMENT STRUCTURAL SECTIONS SHOWN ON THESE PLANS ARE PRELIMINARY ESTIMATES. ACTUAL THICKNESS OF PAVEMENT SURFACING AND BASE COURSES SHALL BE AS DETERMINED BY THE GEOTECHNICAL ENGINEER AFTER COMPLETION OF ROUGH GRADING BASED ON "R"-VALUE TESTS OF COMPLETED SUBGRADE MATERIAL AND THE TRAFFIC INDEXES (T.I.'S) SHOWN ON THE PLAN DETAILS, SUBJECT TO APPROVAL BY THE CITY ENGINEER. ADDITIONAL GRADING MAY BE NECESSARY TO ADJUST SUBGRADE ELEVATIONS TO ACCOMMODATE THE FINAL STRUCTURAL THICKNESS.
- 22.THE UPPER 12 INCHES OF FILL OR NATIVE SOIL BELOW THE BOTTOM OF AGGREGATE BASE OR SUBBASE COURSE (BELOW SUBGRADE) IN PAVEMENT AREAS, AND THE UPPER 6 INCHES OF FILL OR NATIVE SOIL BELOW THE CONCRETE OR SAND COURSE IN WALKWAY AREAS SHALL BE COMPACTED TO A MINIMUM OF 95% OF MAXIMUM DENSITY.
- 23.BEFORE PLACEMENT OF AGGREGATE BASE OR SUBBASE MATERIAL IN PAVEMENT AREAS, THE SUBGRADE SOIL SHALL BE REVIEWED AND TESTED BY THE GEOTECHNICAL ENGINEER.
- DURING PAVING OPERATIONS, STRUCTURAL SECTION COMPACTION SHALL BE OBSERVED AND TESTED BY THE GEOTECHNICAL ENGINEER.
- 24.BEFORE BEGINNING WORK, CONTRACTOR SHALL OBTAIN APPROVAL FROM THE CITY ENGINEER FOR IMPORT/EXPORT HAUL ROUTES AND TIMES.
- 25.CONTRACTOR SHALL NOTIFY THE CITY COMMUNITY DEVELOPMENT AND COMMUNITY SERVICES DEPARTMENTS, THE GEOTECHNICAL ENGINEER, THE GEOLOGIST, AND THE ENGINEER AT LEAST 48 HOURS BEFORE START OF ANY GRADING WORK AND OF THE TIME AND LOCATION OF PRECONSTRUCTION CONFERENCE.
- 26.AT THE TIME OF THE PRECONSTRUCTION CONFERENCE THE GEOTECHNICAL ENGINEER IS TO DISCUSS WITH THE CITY COMMUNITY SERVICES DEPARTMENT STAFF THE LEVEL OF OBSERVATION AND TESTING TO BE REQUIRED
- 27.SITE DEVELOPMENT FINISH SURFACE GRADING CRITERIA
- IT IS THE DESIGN ENGINEER'S INTENT THAT THE FOLLOWING MINIMUM AND MAXIMUM SLOPES (GRADIENTS) BE MAINTAINED ON CONSTRUCTED FINISH SURFACES. IT SHALL BE CONTRACTOR'S RESPONSIBILITY TO VERIFY THAT THESE MINIMUM AND MAXIMUM SLOPES ARE ADHERED TO AND MAINTAINED DURING CONSTRUCTION.

SURFACE TYPE	MINIMUM SLOPE	MAXIMUM SLOPE
CONCRETE WALK, CROSS-SLOPE	0.5% (200:1) 0.5% (200:1)	2.0% (50:1) *5.0% (20:1)
CONCRETE WALK, LONGITUDINAL SLOPE CONCRETE PAVEMENT	0.5% (200:1)	*5.0% (20:1) *5.0% (20:1)
ASPHALT PAVEMENT	1.0% (100:1)	*5.0% (20:1)
GRADED LANDSCAPE SWALES	1.5% (67:1)	16% (6:1)
GRADED LANDSCAPE AREAS	2.0% (50:1)	50% (2:1)

*ACCESSIBLE RAMPS MAY EXCEED THESE MAXIMUMS BUT MUST COMPLY WITH ADA REQUIREMENTS.

EARTHWORK

ESTIMATED EARTHWORK QUANTITIES:	EXCAVATION	<u>EMBANKMENT</u>
SITE GRADING	1030 C.Y.	450 C.Y.
LOSS DUE TO CLEARING & GRUBBING	−150 C.Y.	+125 C.Y.
SUBTOTAL	880 C.Y.	575 C.Y.
SHRINKAGE @ 25%	220 C.Y.	
TOTAL	660 C.Y.	575 C.Y.

- (1) ESTIMATED QUANTITIES SHOWN ABOVE ARE COMPUTED FROM EXISTING GROUND ELEVATIONS TO THE PROPOSED ELEVATIONS ON THIS PLAN.
- (2) CLEARING AND GRUBBING OPERATIONS ARE ASSUMED TO RESULT IN A LOSS OF 0.15' OVER THE GRADED AREA.
- (3) FOR THE PURPOSE OF THESE EARTHWORK CALCULATIONS, THE PAVEMENT STRUCTURAL SECTION IS ASSUMED TO BE 0.75'
- (4) ESTIMATED QUANTITIES DO NOT INCLUDE EXCAVATION FOR UTILITY TRENCHES.

EXPORT = 85 C.Y.

— A.C. PAVEMENT

MIRAFI 140N ·

FILTER FABRIC

24" SAND/COMPOST MIX

& 10-20% CLEAN TOPSOIL.

CONTENT. (30% POROSITY)

60-70% SAND, 15-25% COMPOST

pH 5.5 TO 7.5 W/8-12% ORGANIC

12" GRAVEL -

(40% POROSITY)

WASHED & OPEN GRADED

28.QUALITY REVIEW AND REPORTING REQUIREMENTS

- A. CONCLUSION OF ROUGH GRADING, A LICENSED LAND SURVEYOR RETAINED BY CONGRACTOR SHALL SPOT CHECK AND PROVIDE TO THE CITY OF GOLETA, THE OWNER AND THE ENGINEER WRITTEN CERTIFICATION THAT PAVEMENT SUBGRADE ELEVATIONS ARE IN CONFORMANCE WITH APPROVED GRADING PLAN. CERTIFICATION SHALL INCLUDE A DRAWING SHOWING LOCATION OF SPOT ELEVATION READINGS.
- B. UPON COMPLETION OF FINISH GRADING AND AFTER INSTALLATION OF LANDSCAPE PLANTINGS AND IRRIGATION BUT BEFORE PLACEMENT OF ANY MULCH OR WOOD CHIPS, LICENSED LAND SURVEYOR RETAINED BY CONTRACTOR SHALL DETERMINE CONSTRUCTION RECORD ELEVATIONS AT LOCATIONS REQUIRED BY THE ENGINEER, GENERALLY DESCRIBED AS SOLLOWS:
 - 1. WALKWAY/RAMP SLOPES AND CROSS-SLOPES.
 - 2. TOP OF CURB, TOP OF PAVEMENT & GUTTER FLOWLINE WITHIN PAVED AREAS.
 - 3. FINISH SUBGRADE AT HIGH POINTS, GRADE BREAKS, FLOWLINES & ADJACENT TO CATCH BASINS WITHIN DIRT AREAS TO BE COVERED WITH MULCH OR
 - ELEVATIONS SHALL BE RECORDED ON A SCREENED REPRODUCIBLE OF THE IMPROVEMENT PLAN PROVIDED BY THE ENGINEER.
- C. GRADING AND IMPROVEMENTS FOUND NOT IN CONFORMANCE WITH APPROVED PLANS AND DESIGN INTENT SHALL BE CORRECTED BY CONTRACTOR AT CONTRACTOR'S EXPENSE. ADDITIONAL SURVEYING TO CONFIRM ELEVATIONS AFTER CORRECTIVE MEASURES SHALL ALSO BE AT CONTRACTOR'S EXPENSE. REQUIREMENTS FOR VARIOUS SURFACING CONDITIONS ARE AS FOLLOWS:
 - NOT LESS 2% (1/4 INCH PER FOOT) SLOPE IN DIRECTION OF SURFACE DRAINAGE AND 0.10 FOOT MAXIMUM DEVIATION FROM DESIGN ELEVATION AT ANY LOCATION.
- A.C. PAVEMENT: NOT LESS 1% (1/8 INCH PER FOOT) SLOPE IN DIRECTION OF SURFACE DRAINAGE AND 0.04 FOOT MAXIMUM DEVIATION FROM DESIGN ELEVATION AT ANY LOCATION.
- NOT LESS 0.5% (1/16 INCH PER FOOT) SLOPE IN DIRECTION OF SURFACE DRAINAGE AND 0.02 FOOT MAXIMUM DEVIATION FROM DESIGN ELEVATION AT ANY LOCATION.

ACKERSTONE AQUA-VIA PERMEABLE PAVER ----

→ VARIES

PERMEABLE PVMT. SECTION

OVER 2" OPEN GRADED BEDDING COURSE

8"MIN-

USE ASTM NO. 8 STONE OR SIMILAR

-6" P.C. CONC. CURB INSTALLED

0%--

FLUSH WITH GRADE

D. FOLLOW-UP REVIEW BY ENGINEER OF MULCHED AREAS SHALL NOT RELIEVE CONTRACTOR OF RESPONSIBILITY FOR ENSURING THAT UNIFORM LAYER OF CORRECT THICKNESS OF MULCH OR CHIPS IS LAID DOWN AND THAT SUCH LAYER DOES NOT OBSTRUCT SURFACE DRAINAGE.

OAKS ROAD GOLETA VALLEY JR. HIGH SCHOOL VIA FIORI CANYON **PROJECT** ROAD SITE COVINGTON VICINITY MAP

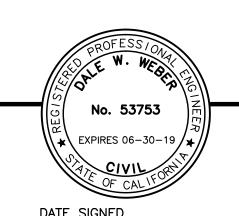
ABBREVIATIONS

NO SCALE

AGGREGATE BASE ASPHALTIC CONCRETE ASSESSORS PARCEL NUMBER A.P.N. BEGIN CURVE BACK OF WALK ELEVATION CLEARANCE CENTER LINE CONST. CONSTRUCT CONC CONCRETE CUBIC YARD DROP INLET DIA. DIAMETER DOWN SPOUT END CURVE **ELEVATION** FINISH FLOOR ELEVATION FIRE HYDRANT FLOWLINE INVERT ELEVATION LENGTH LINEAR FOOT **MAXIMUM** MINIMUM ON CENTER PROPERTY LINE POWER POLE POINT OF REVERSE CURVE PVC POLYVINYL CHLORIDE RADIUS RET. RETURN RIGHT OF WAY ROW **SDMH** STORM DRAIN MANHOLE SMH SEWER MANHOLE STA. STATION STD. **STANDARD** THRUST BLOCK TOP OF CURB ELEVATION TOP OF PAVEMENT ELEVATION TOP OF WALL ELEVATION UG **UNDERGROUND** WATER LINE WATER VALVE W.V.

INDEX TO DRAWINGS

- 1. GENERAL INFORMATION
- 2. DEMOLITION PLAN
- 3. PRELIMINARY GRADING & DRAINAGE PLAN
- 4. PRELIMINARY UTILITY PLAN



CITY OF GOLETA, CALIFORNIA GENERAL INFORMATION CHABAD OF SANTA BARBARA 4065 STOW CANYON ROAD

– PERMEABLE JOINT MATERIAL

- OPEN GRADED ROCK RESERVOIR

BOTTOM OF GRAVEL 0% SLOPE.

SCALE: 1"=2"

USE ASTM 57 STONE OR SIMILAR.

USE ASTM #8, 89 OR 9 STONE

──6" P.C. CONC. CURB

WORK ORDER W.O. 0465 SHEET OF **4** FILE#



ATIENTION:

ALL UNDERGROUND UTILITIES AND SUBSTRUCTURES SHOWN HEREON WERE OBTAINED FROM THE BEST AVAILABLE SOURCES
AND ARE PRESUMED TO BE TO BE ACCURATE
AND COMPLETE, BUT SINCE THE INFORMATION
WAS OBTAINED FROM OTHERS, THE OFFICE OF
UNDERSTANDAMENT OF THE OFFICE OF
SAID INFORMATION AS BEING ACCURATE AND
SAID INFORMATION AS S

MAC Design Associates CIVIL ENGINEERING * LAND PLANNING * BRIDGE DESIGN DRAWN ___TLA__ DALE W. WEBER PROJECT ENGINEER R.C.E. 53753 (EXP. 6-30-19)

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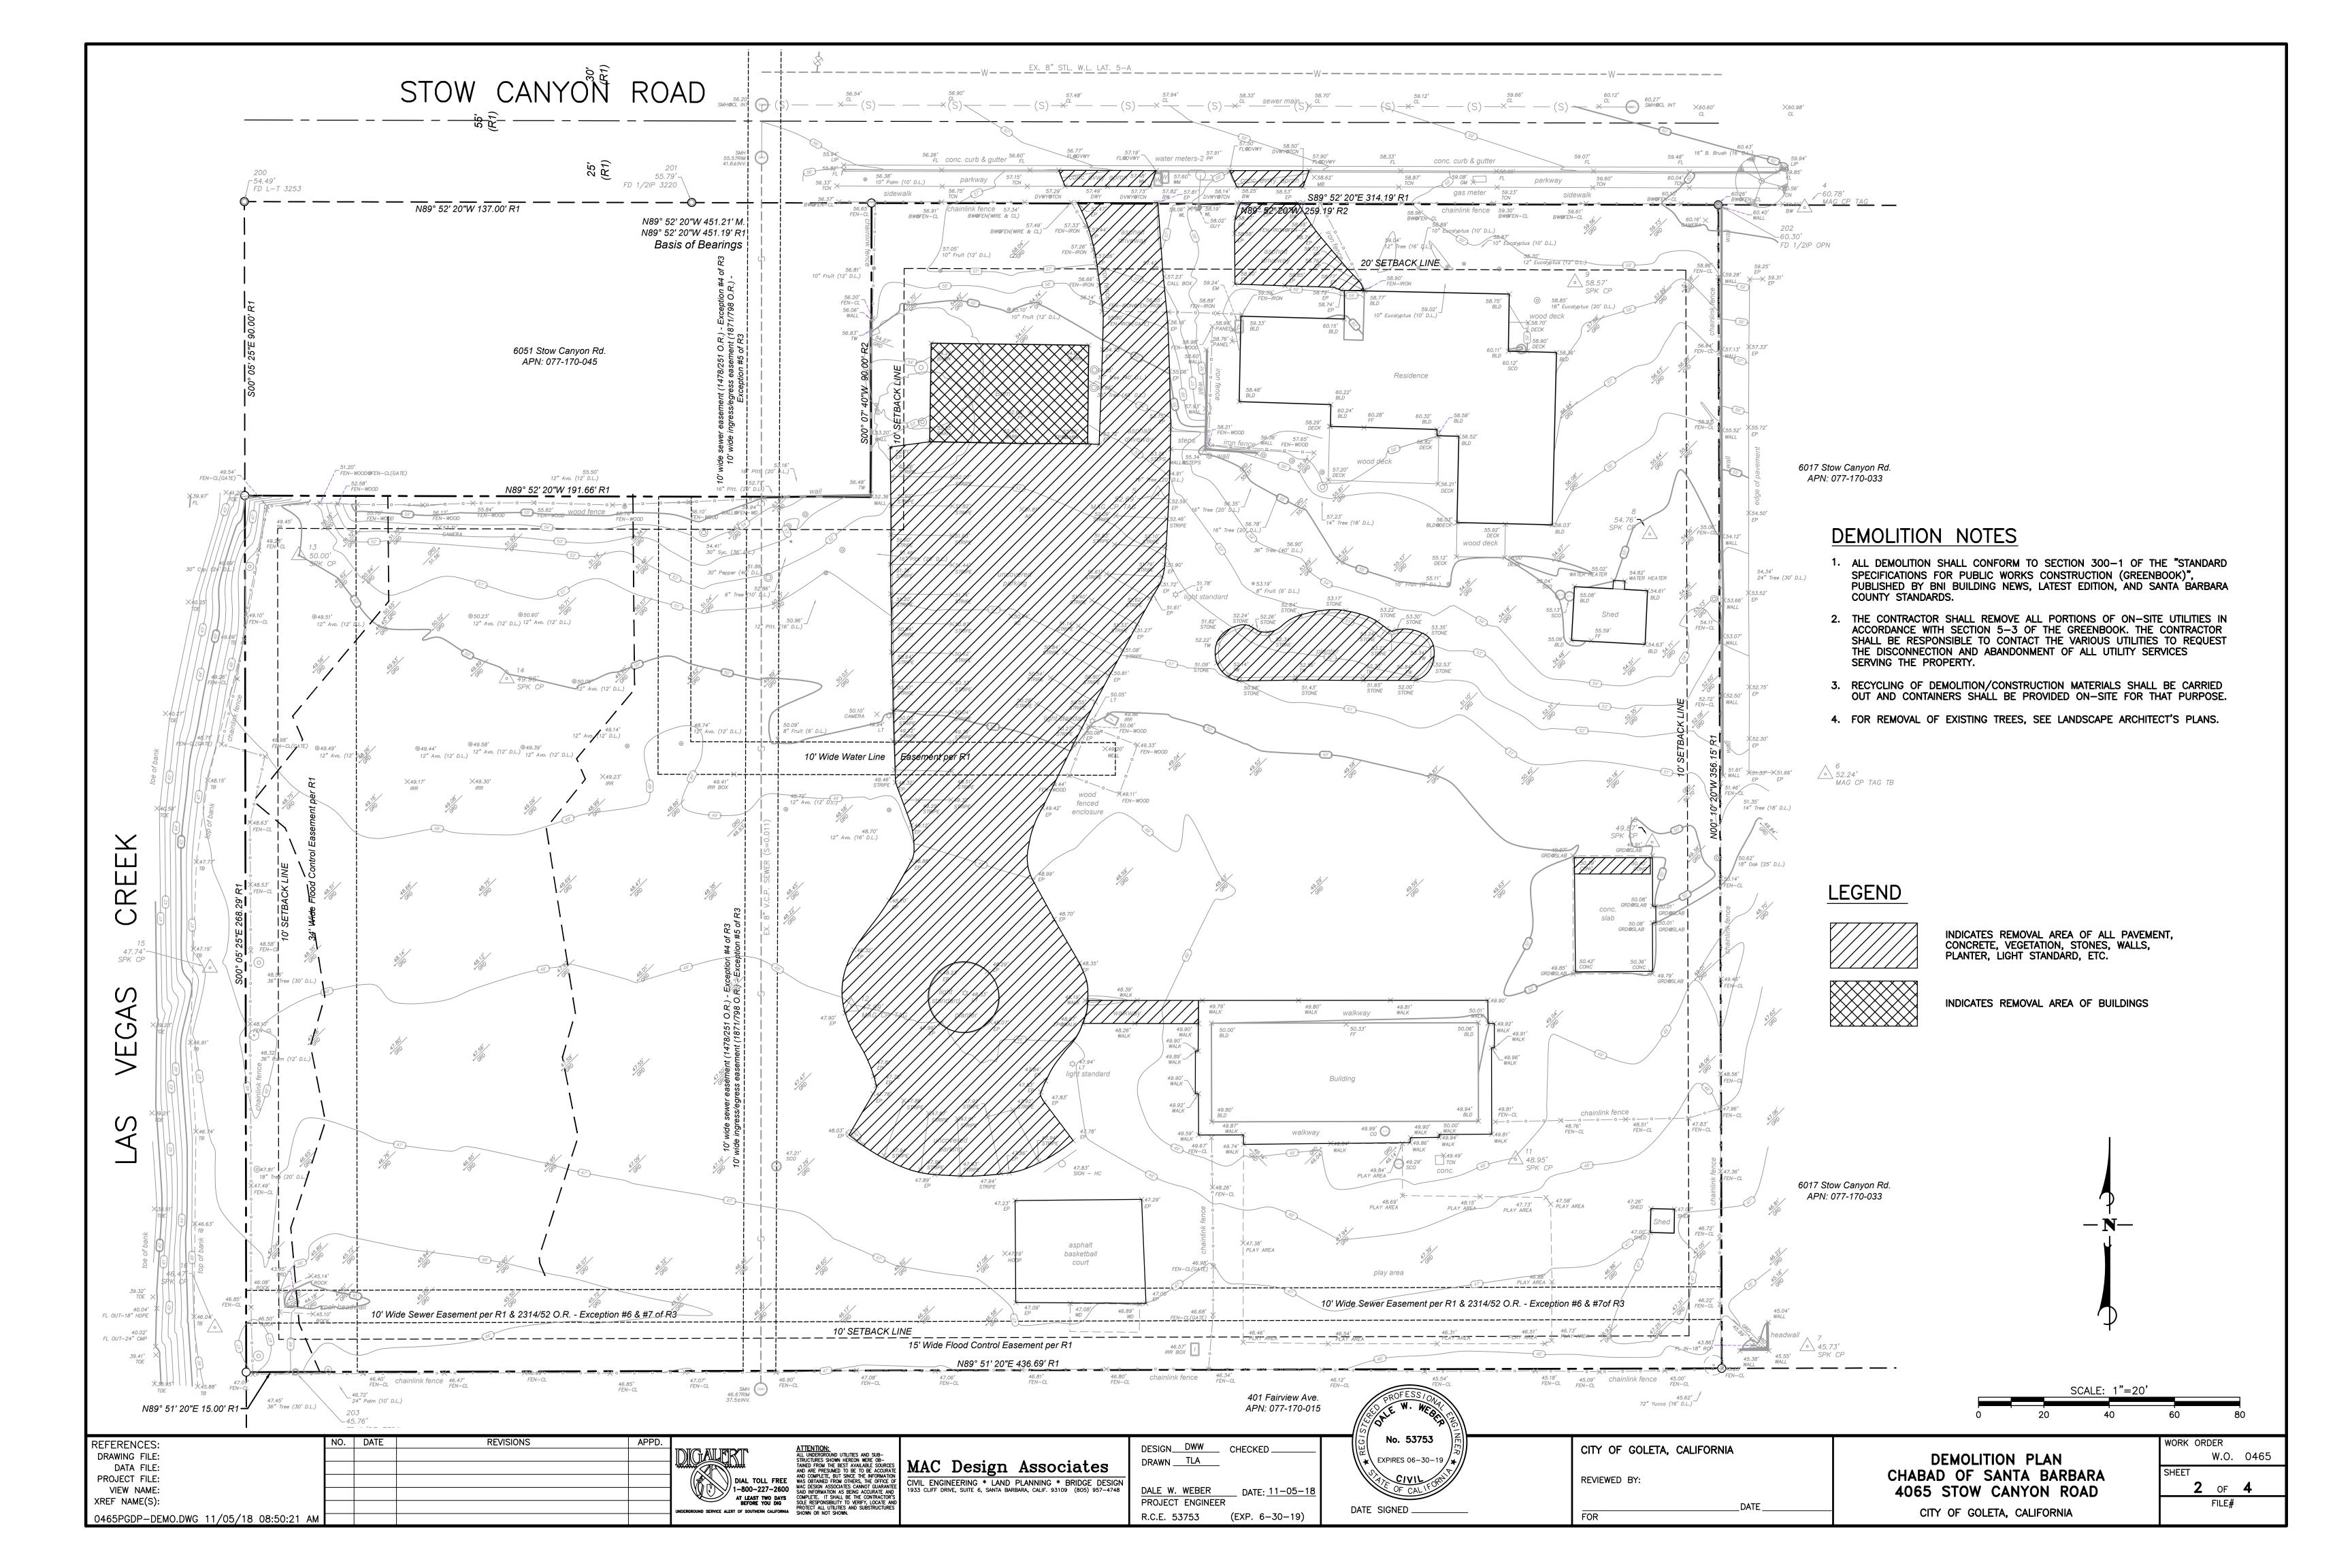
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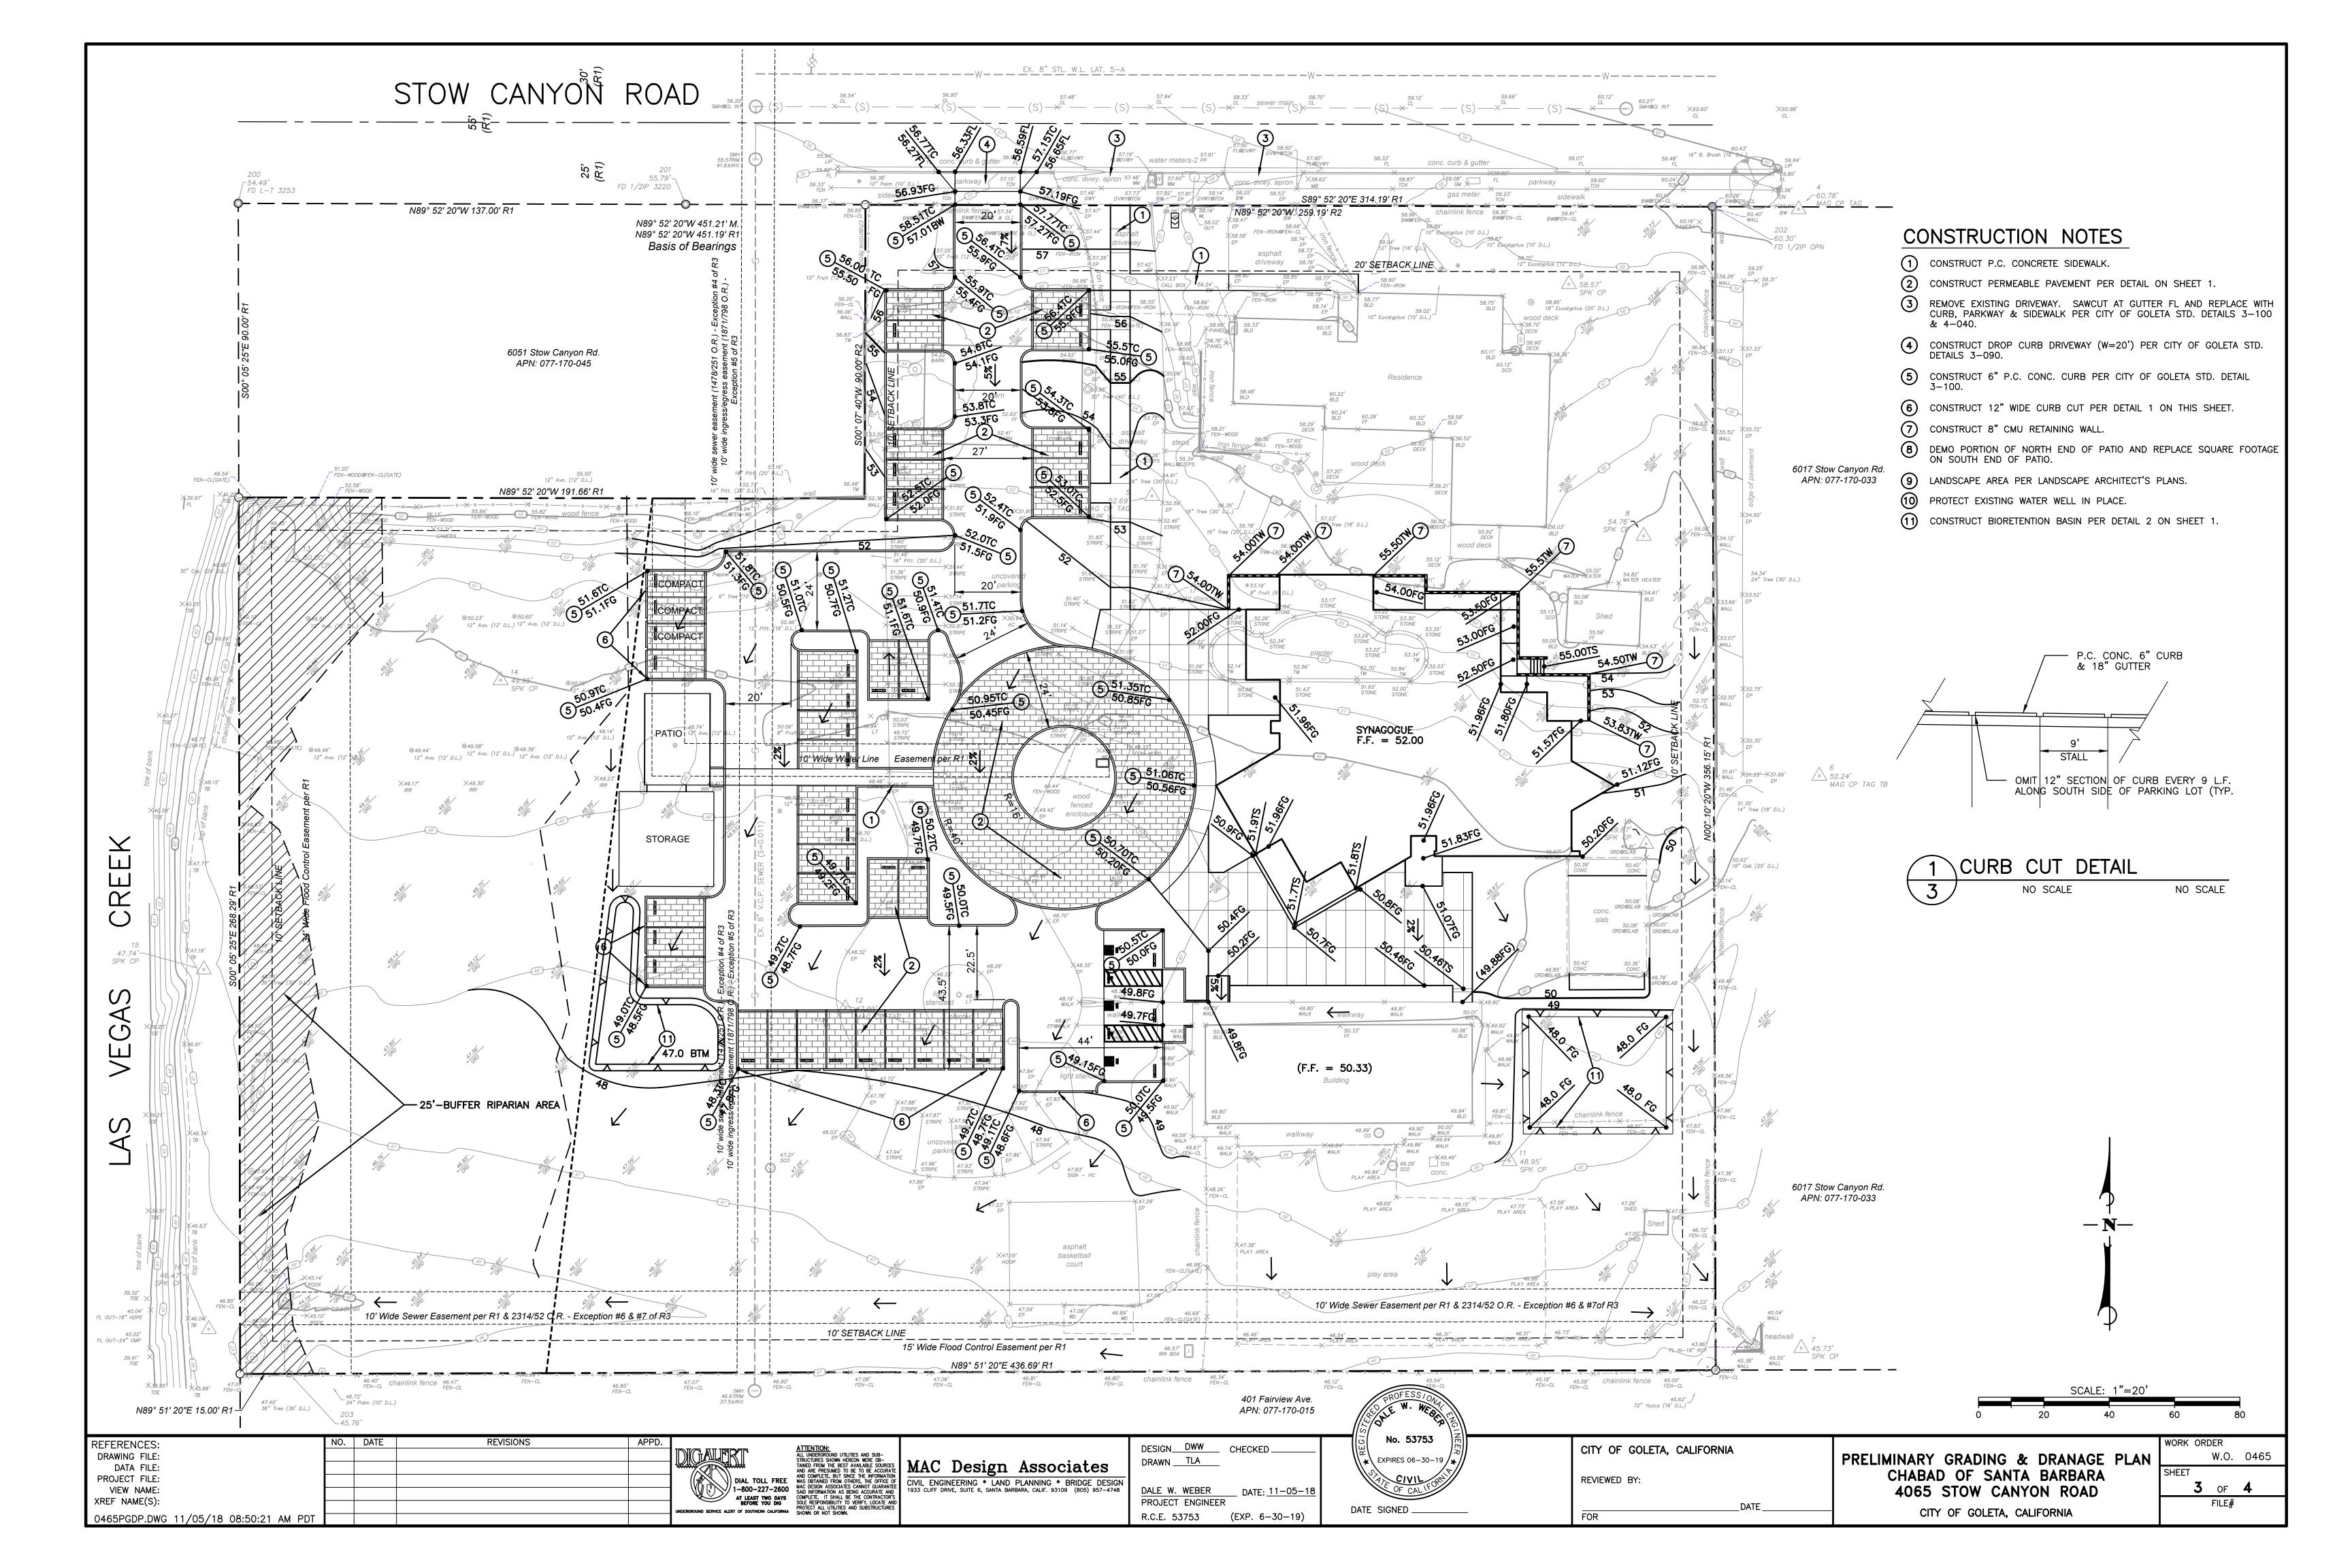
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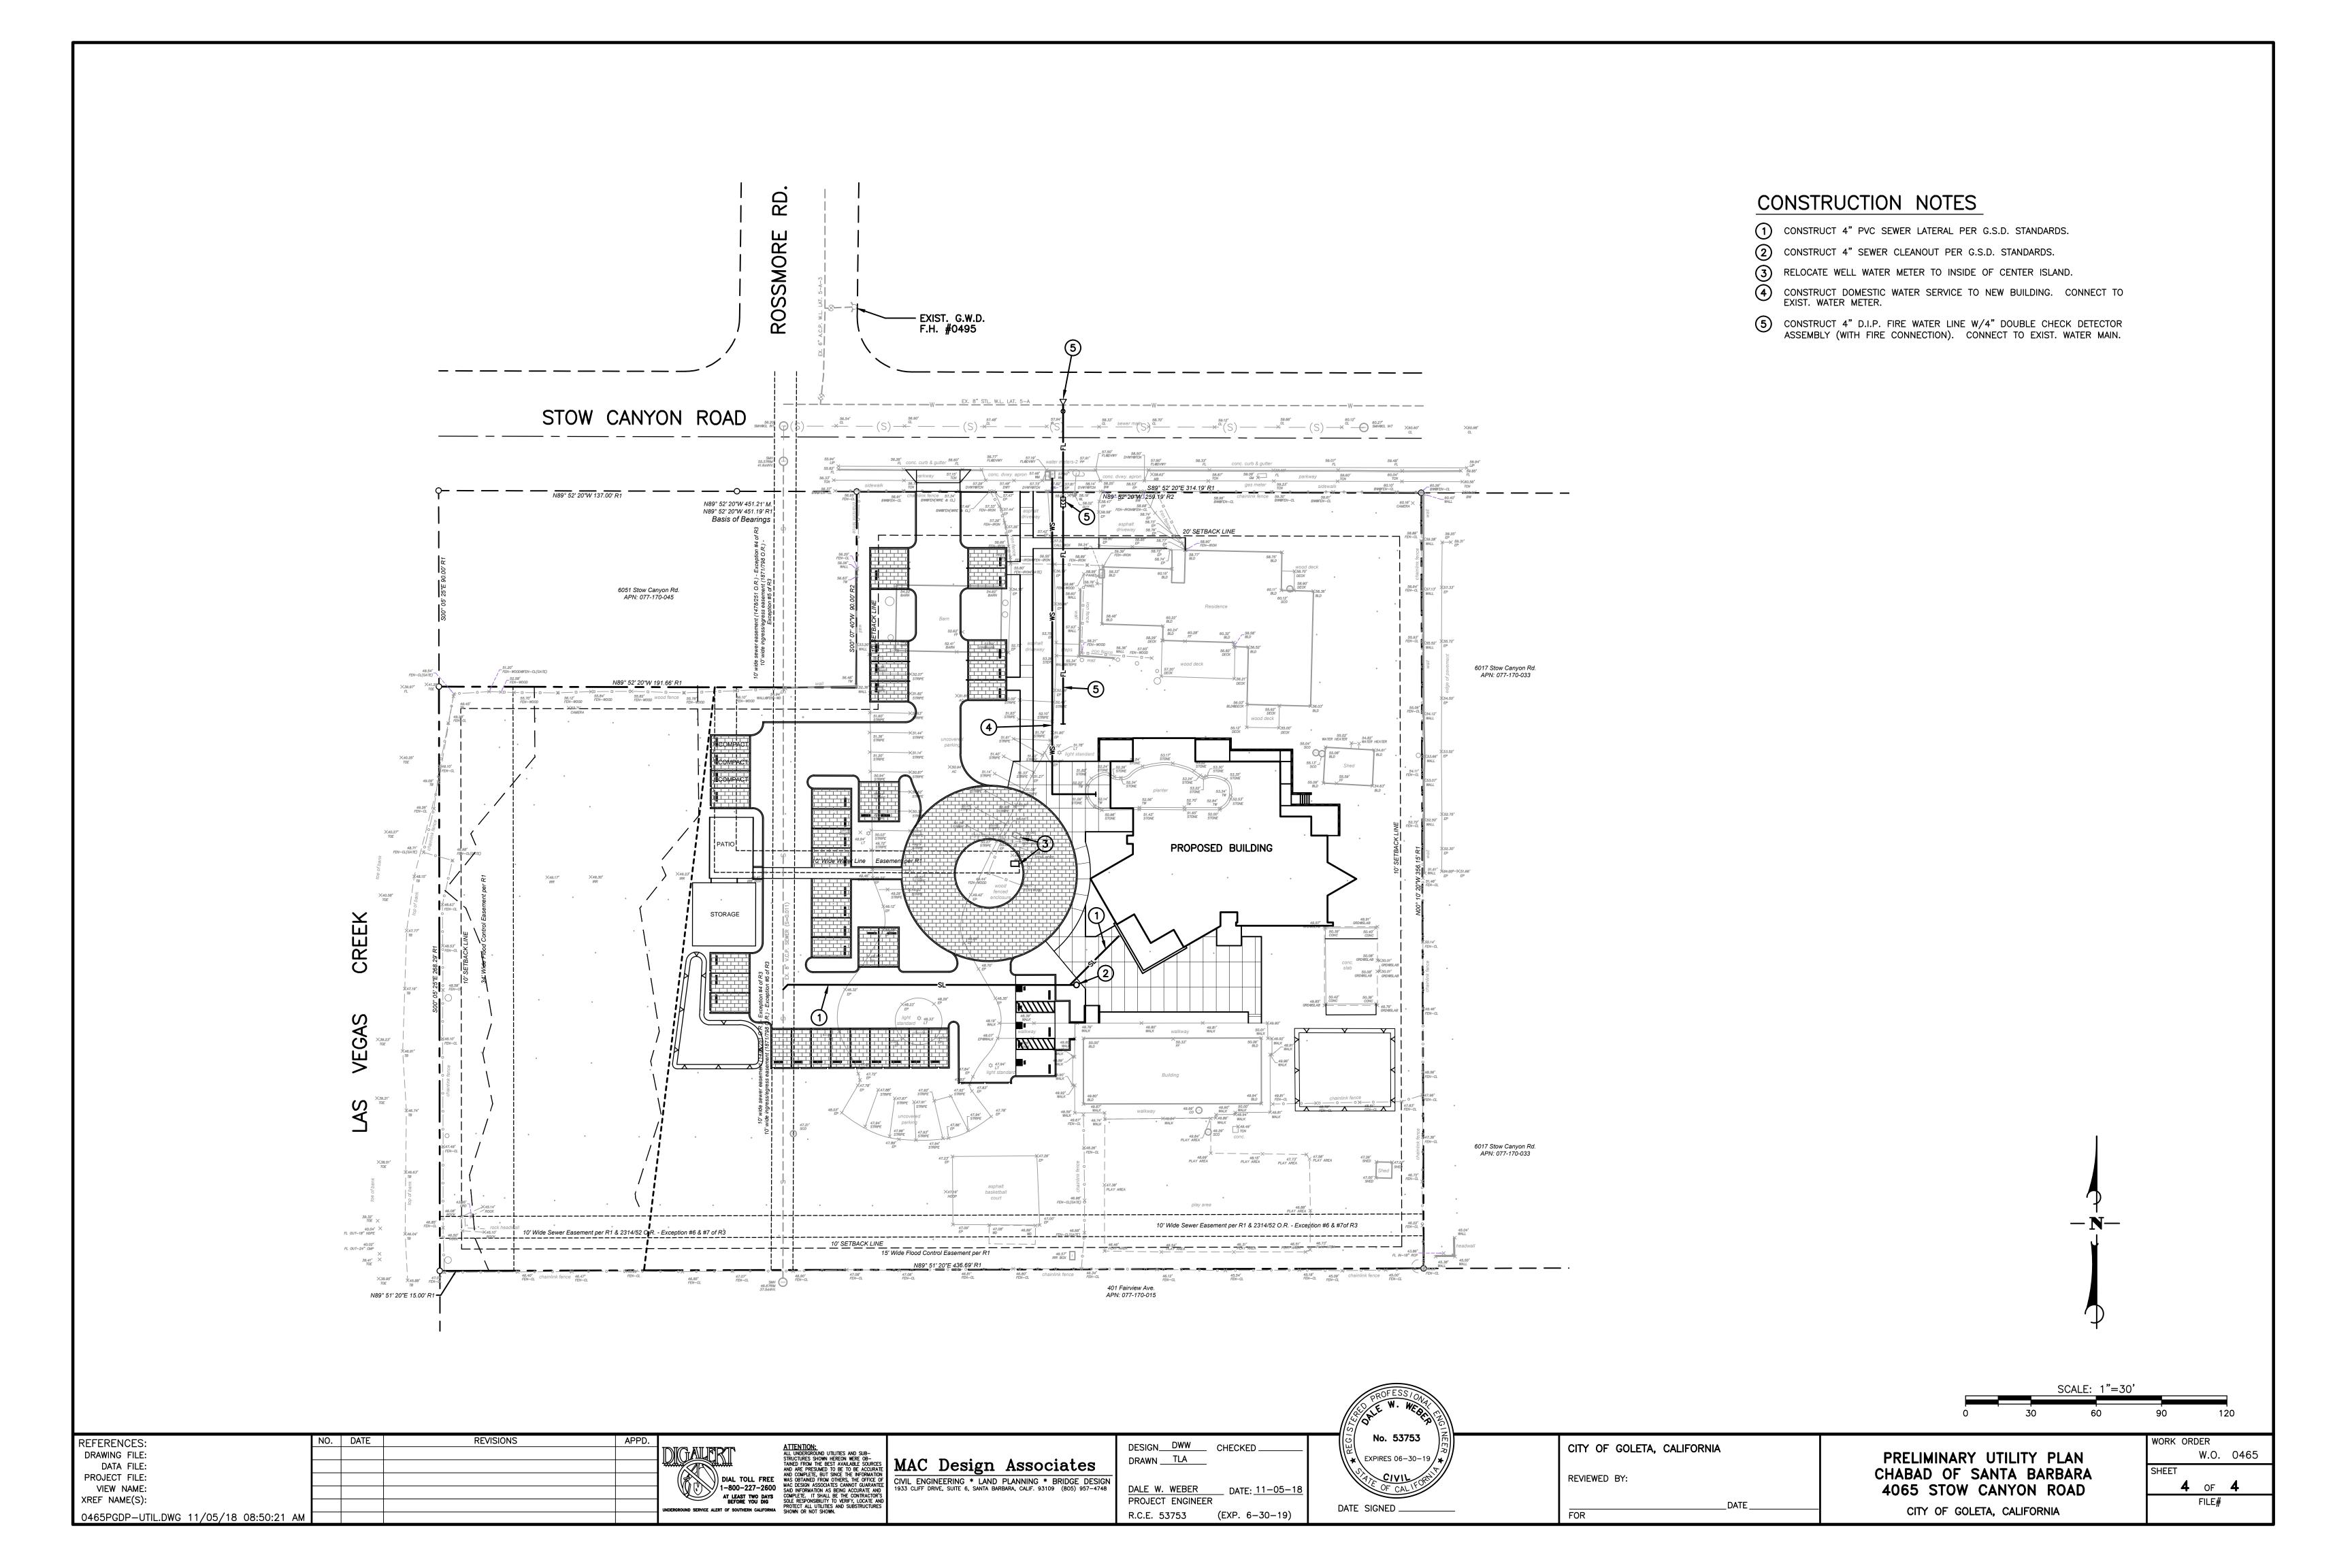
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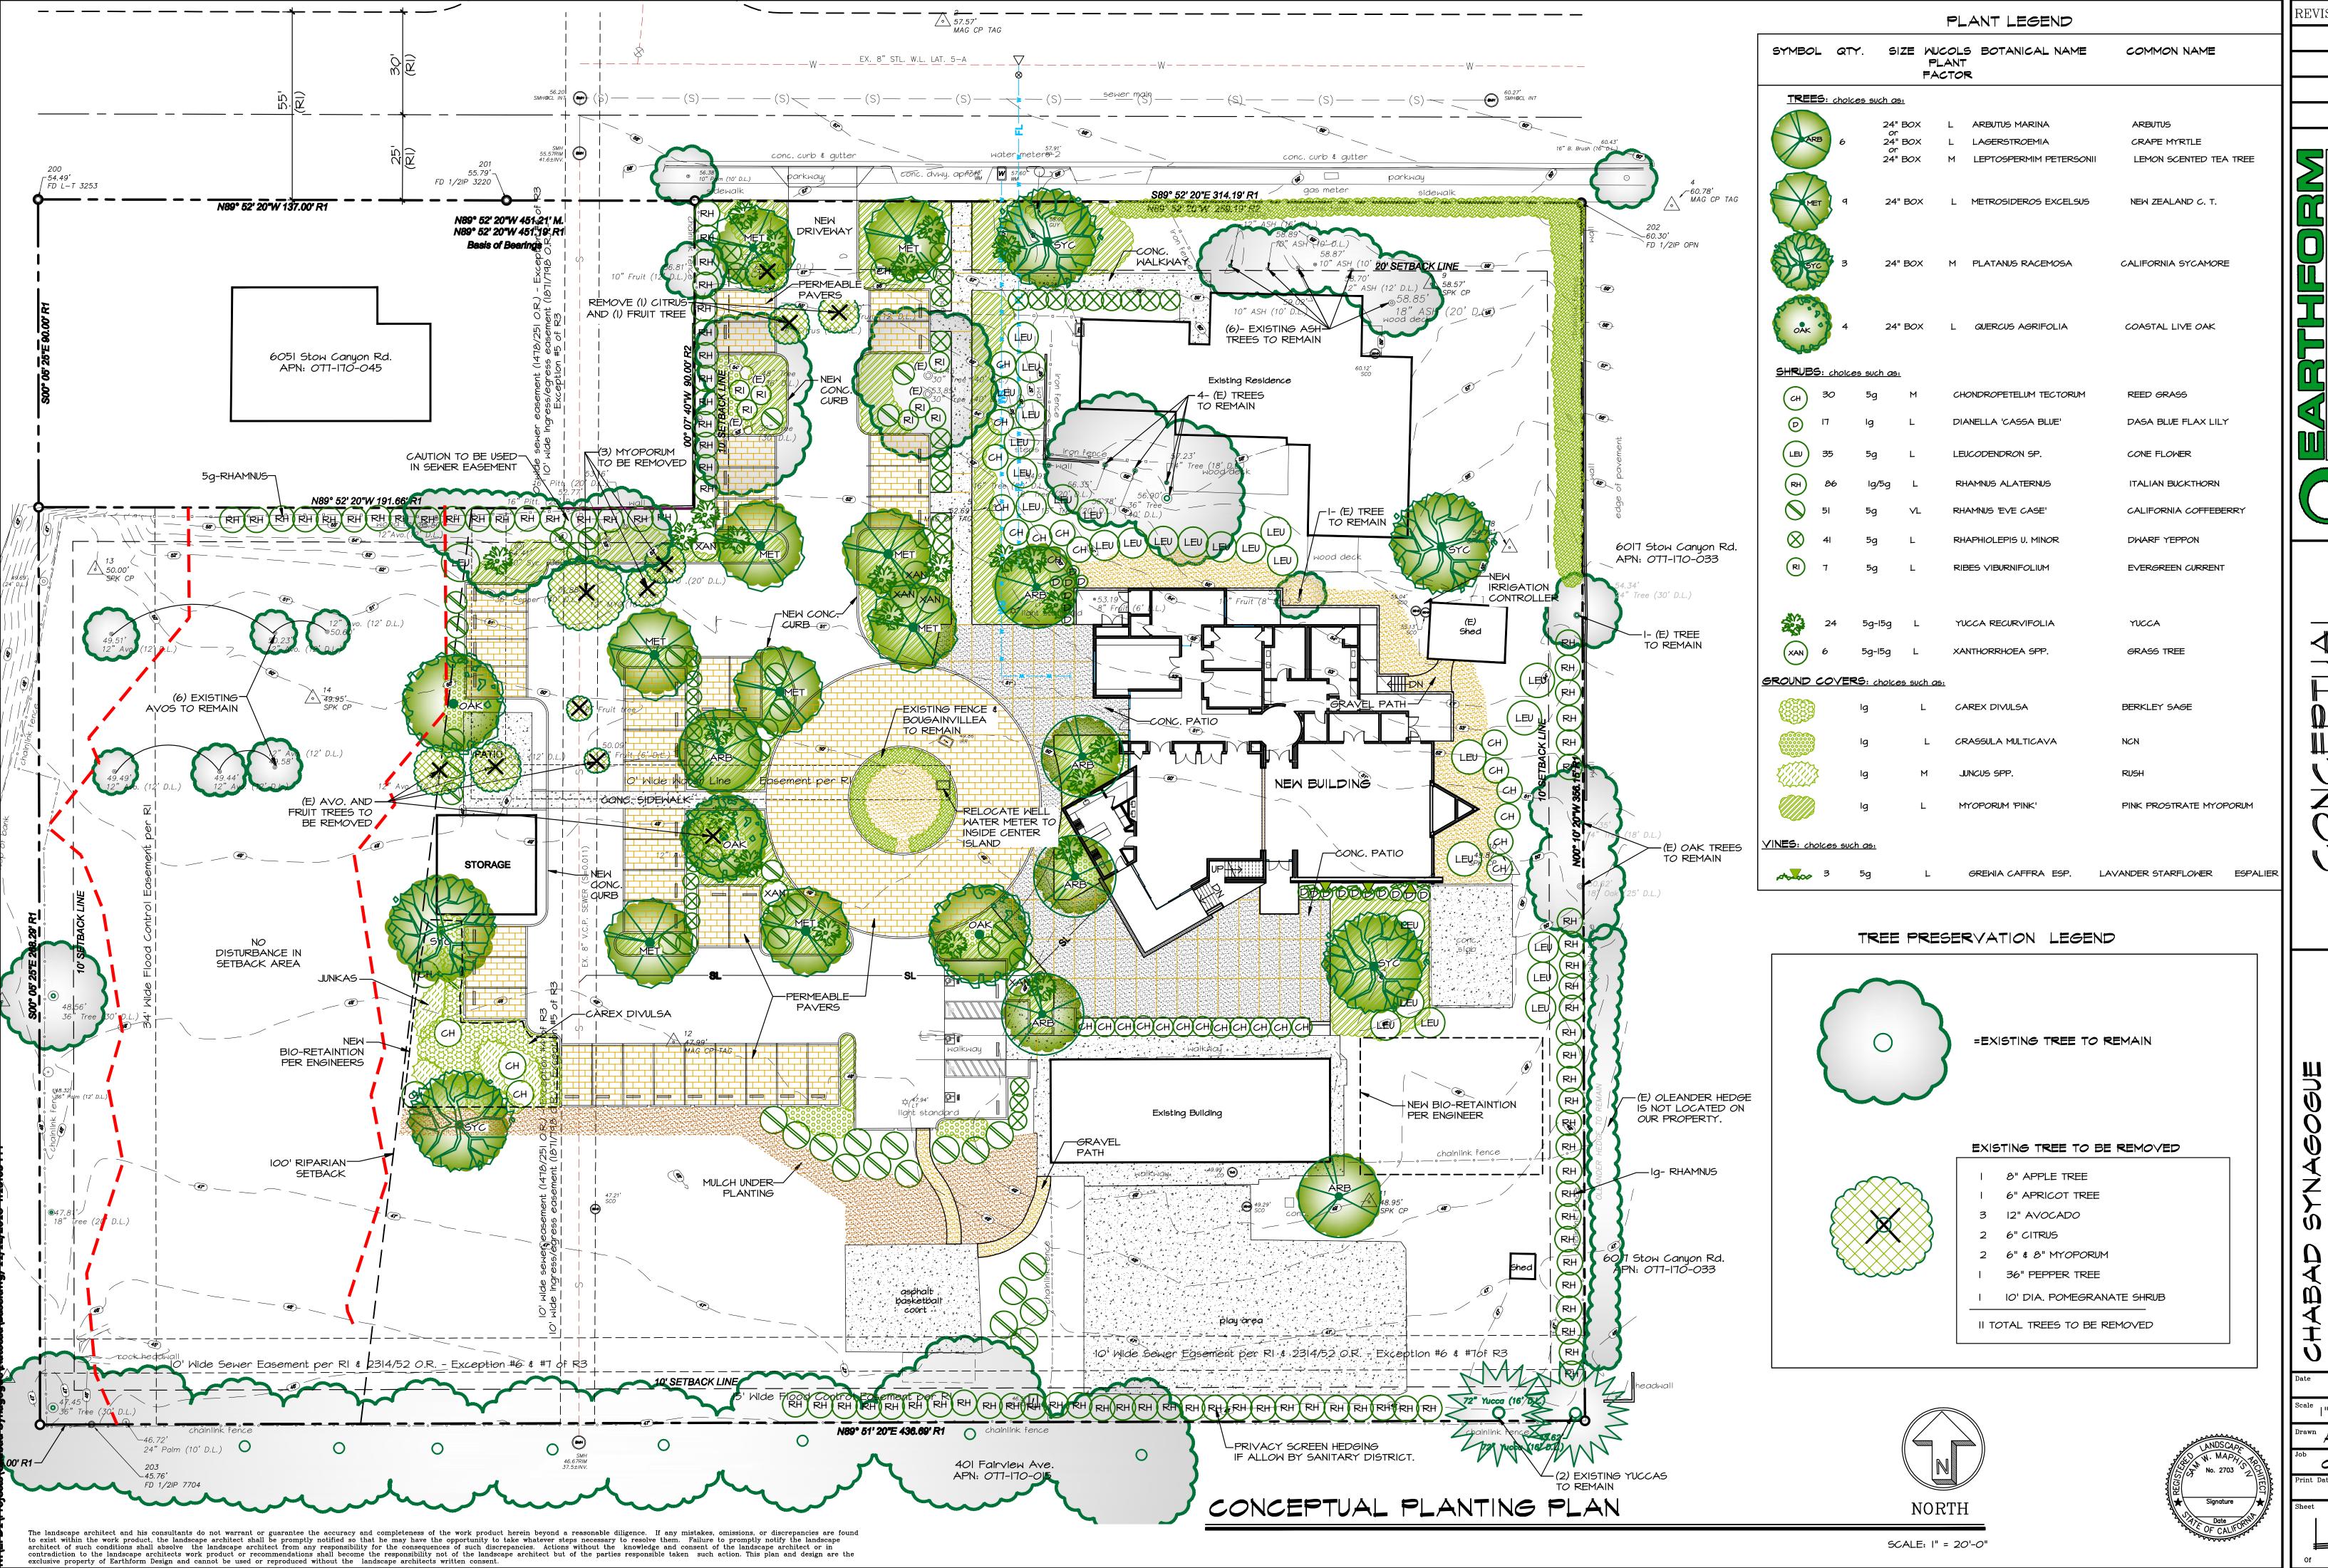
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CITY OF GOLETA, CALIFORNIA









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11/9/18 A. NUÑO



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CHABAD