### HOLLISTER VILLAGE APARTMENTS - 27 UNIT BUILDING



## ALL RIGHTS RESERVED.



THOMAS OCHSNER

ARCHITECTURE & PLANNING

### Thomas Ochsner AIA

10 E. Yanonali Street Santa Barbara, CA Tel 805.770.7576 Cel 805.705.6558 tom@toarchitect.com

www.toarchitect.com

CLIENT

**WESTAR ASSOCIATES** 

CORR CORRIDOR

DIA DIAMETER

DIM DIMENSION DIV DIVISION

EAST

EXPANSION JOINT

ELEVATION

EACH

ELEC ELECTRICAL

EMER EMERGENCY

EN EDGE NAIL

ENG ENGINEER

EQ EQUAL(LY)

EQPT EQUIPMENT EQUIP EQUIPMENT

EST ESTIMATE

EXT EXTERIOR

FAST FASTEN(ER)

FAU FORCED AIR UNI

FBO FURNISHED BY OWNER

FINISHED FLOOR

FINISHED GRADE

FLAT HEAD

FLOOR

FLASH FLASH(ING)

FIN FINISH(ED) FIXT FIXTURE

DIAG DIAGONAL

DN DOWN

CSK COUNTERSINK

DEMO DEMOLISH; DEMOLITION

DOUGLAS FIR

**ABBREVATIONS** FOC FACE OF CONCRETE FOF FACE OF FINISH FOM FACE OF MASONRY PERPENDICULAR FOP FACE OF PLYWOOD FOS FACE OF STUDS FOW FACE OF WALL RISER ANCHOR BOLT FOOT OR FEET ABOVE RAD RADIUS FTG FOOTING ASPHALTIC CONCRETE RCP REFLECTED CEILING PLAN FURR FURRING AREA DRAIN GA GAUGE REFRIGERATOR DISABILITIES ACT GALV GALVANIZE(D) ADJ ADJUSTABLE / ADJACENT REG REGISTER GC GENERAL CONTRACTOR REINF REINFORCE(D) AFF ABOVE FINISHED FLOOR GLASS / GLAZING GYP GYPSUM ALUMINUM GYP BD GYPSUM BOARD HB HOSE BIB HDR HEADER AP ACCESS PANEL RO ROUGH OPENING HDWR HARDWARE APPROX APPROXIMATELY RWD REDWOOD HOR / HORIZONTAL ARCH ARCHITECT(URAL) S SOUTH ASPH ASPHALT ASTM AMERICAN SOCIETY FOR SCHED SCHEDULE TESTING MATERIALS SD STORM DRAIN HR HANDRAIL: HOUR AUTO AUTOMATIC HEIGHT AVG AVERAGE HTR HEATER SHTG SHEATHING HW (R) HOT WATER (RETURN) SHWR SHOWER SIM SIMILAR ID INSIDE DIAMETER BLK BLOCK INCH / INCHES BLKG BLOCKING SOG SLAB ON GRADE BN BOUNDARY NAILING BOT BOTTOM INT INTERIOR SQFT SQUARE FEET SQIN SQUARE INCH(ES) JT JOINT CATCH BASIN CUBIC FOOT LAM LAMINATE(D) CAST IRON: CONTRACTOR STANDARD LAV LAVATORY LAG BOLT CAST IN PLACE STOR STORAGE STRUCT STRUCTURE LINEAR FOOT (FEET) LEFT HAND CENTER LINE SUSP SUSPENDED LIBRARY CEILING SYM SYMMETRICAL LOW POINT CLOS CLOSET SYN SYNTHETIC CLR CLEAR SYS SYSTEM LVR LOUVER CMU CONCRETE MASONRY MACH MACHINE CO CLEAN/CLEAR OUT MAINT MAINTENANCE MAS MASONRY CONC CONCRETE TBS TO BE SELECTED MATL MATERIAL CONST CONSTRUCTION TELEPHONE CONT CONTINUOUS

OC ON CENTER

OPG / OPENING

PED PEDESTAL

PER PERIMETER

PLAS PLASTER

PLYWD PLYWOOD

PRCST PRE-CAST

PROP PROPERTY

PREFAB PREFABRICATED

PSF POUNDS PER SQUARE

PSI POUNDS PER SQUARE INCH

PERE PERFORATED PERP PERPENDICULAR


PL PROPERTY LINE

OZ OUNCE

OD OUTSIDE DIAMETER

OFCI OWNER FURNISHED CONTRACTOR INSTALLED

P PAINT (NUMBER - SEE

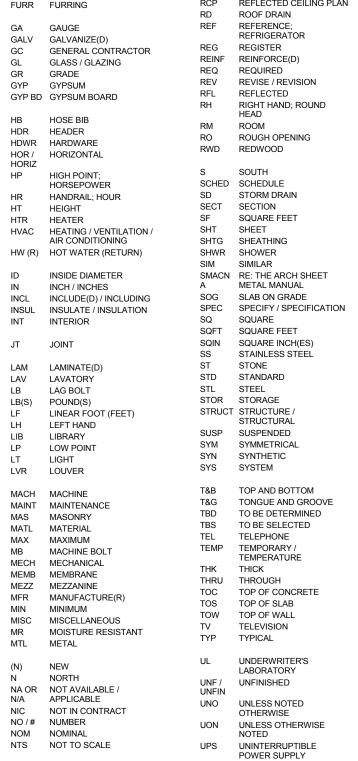

VAPOR BARRIER

VEST VESTIBULE

VNR VENEER

VGDF VERTICAL GRAIN

VOLUME

VTR VENT THRU ROOF

WITH

WIN WINDOW


WATER CLOSET

WROUGHT IRON

WIDE ELANGE WATER HEATER

WP WATERPROOF(ING)

WWF WELDED WIRE FABRIC

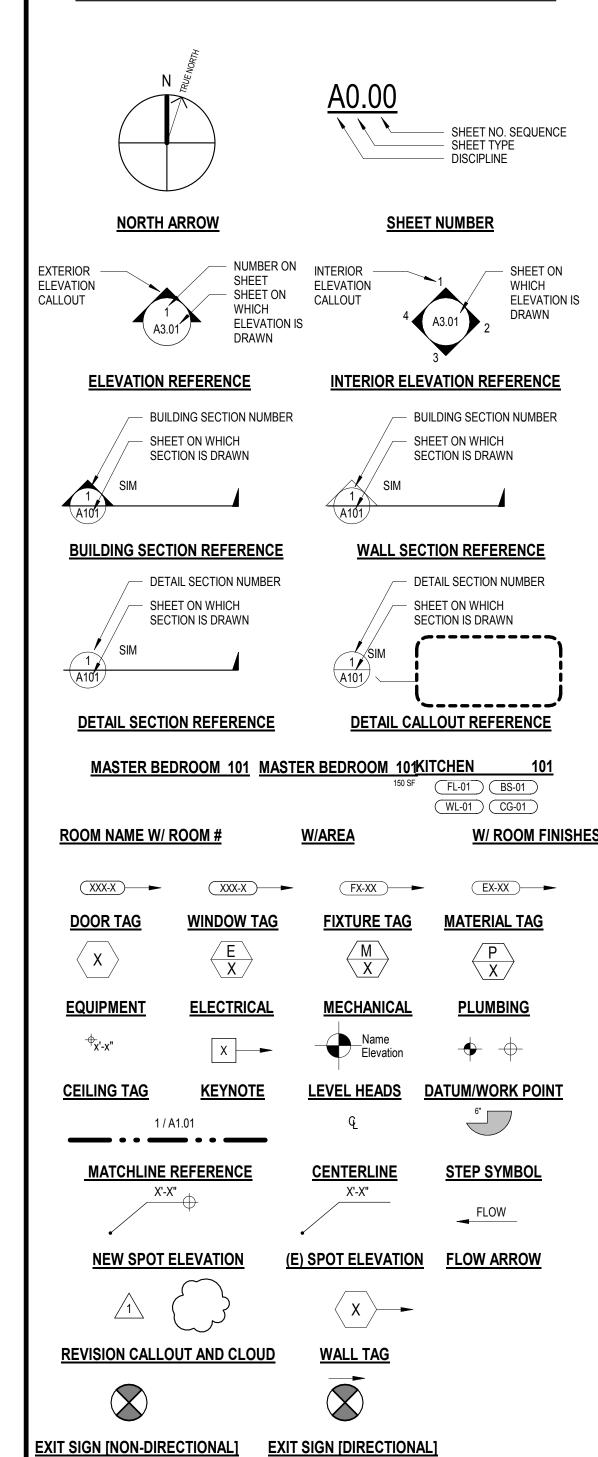

**SYMBOLS** 

#### **AREA CALCULATION** R-2, RESIDENTIAL UNIT 1 - STUDIO UNIT 2 - STUDIO UNIT 3 - STUDIO UNIT 4 - STUDIO UNIT 5 - 1 BEDROOM UNIT 6 - 1 BEDROOM UNIT 7 - STUDIO UNIT 8 - STUDIO UNIT 9 - STUDIO UNIT 10 - STUDIO UNIT 13 - STUDIO UNIT 14 - STUDIO UNIT 17 - STUDIO UNIT 18 - STUDIO UNIT 21 - STUDIO UNIT 22 - STUDIO UNIT 25 - STUDIO UNIT 26 - 1 STUDIO S-2, GARAGE GARAGE 1 GARAGE 2 GARAGE 3 U, MECH/ UTILITY STORAGE STORAGE STORAGE STORAGE UTILITY 1 UTILITY 2

PRIVATE OPEN SPACE CALCULATION		
AREA NAME	AREA	
UNIT 1 PATIO	163 SF	
UNIT 2 PATIO	159 SF	
UNIT 3 PATIO	215 SF	
UNIT 4 PATIO	228 SF	
UNIT 5 PATIO	271 SF	
UNIT 6 PATIO	274 SF	
UNIT 7 PATIO	297 SF	
UNIT 8 PATIO	283 SF	
UNIT 9 PATIO	419 SF	
UNIT 10 PATIO	61 SF	
UNIT 11 PATIO	80 SF	
UNIT 12 PATIO	80 SF	
UNIT 13 PATIO	57 SF	
UNIT 14 PATIO	57 SF	
UNIT 15 PATIO	80 SF	
UNIT 16 PATIO	80 SF	
UNIT 17 PATIO	60 SF	
UNIT 18 PATIO	60 SF	
UNIT 19 PATIO	80 SF	
UNIT 20 PATIO	80 SF	
UNIT 21 PATIO	56 SF	
UNIT 22 PATIO	56 SF	
UNIT 23 PATIO	80 SF	
UNIT 24 PATIO	80 SF	
UNIT 25 PATIO	159 SF	
UNIT 26 PATIO	163 SF	

#### PLANNING NET AREA CALCULATION 553 SF UNIT 11 - 1 BEDROOM UNIT 12 - 1 BEDROOM UNIT 15 - 1 BEDROOM UNIT 16 - 1 BEDROOM UNIT 19 - 1 BEDROOM UNIT 20 - 1 BEDROOM 658 SF 553 SF UNIT 23 - 1 BEDROOM UNIT 24 - 1 BEDROOM UNIT 27 - 1 BEDROOM 16452 SF 2568 SF 1318 SF 1703 SF 5589 SF 117 SF

107 SF

#### DDIVATE ODEN CDACE

PRIVATE OPEN SPACE CALCULATION		
AREA NAME	AREA	
UNIT 1 PATIO	163 SF	
UNIT 2 PATIO	159 SF	
UNIT 3 PATIO	215 SF	
UNIT 4 PATIO	228 SF	
UNIT 5 PATIO	271 SF	
UNIT 6 PATIO	274 SF	
UNIT 7 PATIO	297 SF	
UNIT 8 PATIO	283 SF	
UNIT 9 PATIO	419 SF	
UNIT 10 PATIO	61 SF	
UNIT 11 PATIO	80 SF	
UNIT 12 PATIO	80 SF	
UNIT 13 PATIO	57 SF	
UNIT 14 PATIO	57 SF	
UNIT 15 PATIO	80 SF	
UNIT 16 PATIO	80 SF	
UNIT 17 PATIO	60 SF	
UNIT 18 PATIO	60 SF	
UNIT 19 PATIO	80 SF	
UNIT 20 PATIO	80 SF	
UNIT 21 PATIO	56 SF	
UNIT 22 PATIO	56 SF	
UNIT 23 PATIO	80 SF	
UNIT 24 PATIO	80 SF	
UNIT 25 PATIO	159 SF	
UNIT 26 PATIO	163 SF	
UNIT 27 PATIO	80 SF	

#### **OPEN SPACE**

COMMON OPEN SPACE: 40% OPEN SPACE REQUIRED

PROVIDED: LOTS 4, 5, 6 & 10; 267,908 SF COMMON OPEN SPACE, 658,091 SF TOTAL AREA, 40.7%

PRIVATE OPEN SPACE: 20% OF GROSS UNIT AREA REQUIRED

PROVIDED: 22.8% GROSS UNIT AREA AVERAGE

#### **DENSITY CALCULATION**

LOTS 4, 5, 6 & 10. 293 UNITS ON 15.41 ACRES = 19 UNITS/ACRE

#### **PARKING**

REQUIRED: 1 COVERED SPACE PER UNIT = 27 SPACES (INC. 1 ACCESSIBLE) 1 GUEST SPACE PER 5 UNITS = 6 SPACES TOTAL = 33 SPACES REQUIRED

PROVIDED: 19 STANDARD GARAGE SPACES 1 ACCESSIBLE GARAGE SPACE

9 STANDARD CARPORT SPACES

1 ACCESSIBLE CARPORT SPACE 4 STANDARD UNCOVERED SPACES

1 ACCESSIBLE UNCOVERED SPACE

TOTAL = 35 SPACES PROVIDED

#### LOT COVERAGE AREAS (OVERALL)

BUILDING COVERAGE: 160,279 SF (INC. TRASH ENCLOSURES) = 24.35% LANDSCAPE COVERAGE: 237,993 SF = 36%

#### **PROJECT TEAM**

GOLETA HOLLISTER APARTMENTS LLC DEVELOPER: C/O WESTAR ASSOCIATES 2925 BRISTOL STREET COSTA MESA, CA 92626 (714) 241-0400 CONTACT: CONNOR BEST ARCHITECT: TOM OCHSNER 10 E. YANONALI STREET, SUITE 2D

SANTA BARBARA, CA 93101 Tel 805.770.7576 Cel 805.705.6558 TOM@TOARCHITECT.COM

STRUCTURAL ENGINEER: ASHLEY & VANCE ENGINEERING INC. 210 E. COTA STREET SANTA BARBARA, CA 93101 (805) 962-9966

LANDSCAPE ARCHITECT: RRM DESIGN GROUP WES AROLA 10 E. FIGUEROA STREET #200 SANTA BARBARA, CA 93101

(805) 543-1794

RRMDESIGN.COM CIVIL ENGINEER: SCOTT SMITH P.E. 5553 HOLLISTER AVE.

COAST ENGINEERING SURVEY, INC. GOLETA, CA 93117 (760) 522-1527 SCOTT@ COASTINC.COM

#### PROJECT DESCRIPTION

PROPOSAL FOR 27 RESIDENTIAL APARTMENTS CONSISTING OF 14 GUEST SPACES, TRASH ENCLOSURE, UTILITY ROOMS, STORAGE

#### **PROJECT DATA**

073-030-026, 073-030-027, 073-030-028, & 073-030-033 PROJECT ADDRESS 7000 HOLLISTER AVE **GOLETA, CA 93117 GENERAL PLAN:** DR-20

OCCUPANCY R-2 APARTMENTS, S-2 GARAGES, U CARPORTS

LOT SIZE: 1.42 ACRES, 61,755 SF TYPE OF CONSTRUCTION: V-A 1 HOUR

PROPOSED NUMBER OF STORIES: PROPOSED BUILDING HEIGHT: PROPOSED MEAN BLDG HEIGHT:

SPRINKLERS: YES, NFPA 13R HIGH FIRE:

(\* BUILDING COVERAGE NUMBER FOR 1.42 ACRE LOT ONLY)

**BUILDING COVERAGE:** 14,764 SF (INC. TRASH ENCLOSURE)

#### **DEFERRED SUBMITTALS**

1. ROOF TRUSSES 2. TJI FLOOR JOISTS 3. PRE-FAB EXTERIOR STAIRS 4. EXTERIOR GUARDRAILS, GUARDS, HANDRAILS 5. FIRE SPRINKLER SYSTEM 6. FIRE ALARM MONTORING SYSTEM

7. PRE-MANUFACTURED CARPORTS

#### CODE COMPLIANCE

ALL WORK AND MATERIALS SHALL BE PERFOMED AND INSTALLED IN COMPLIANCE WITH THE CURRENT EDITIONS OF THE FOLLOWING CODES AS ADOPTED BY THE LOCAL GOVERNING AUTHORITIES. NOTHING IN THESE PLANS IS TO BE CONSTRUED TO PERMIT WORK NOT CONFORMING TO THESE CODES.

CITY ORDINANCES

2016 CALIFORNIA BUILDING ADMINISTRATIVE CODE, PART 1

2016 CALIFORNIA MECHANICAL CODE, PART 4

2016 CALIFORNIA BUILDING CODE, PART 2 2016 CALIFORNIA RESIDENTIAL CODE, PART 2.5 5. 2016 CALIFORNIA ELECTRICAL CODE, PART 3

2016 CALIFORNIA PLUMBING CODE, PART 5 8. 2016 CALIFORNIA ENERGY CODE, PART 6 9. 2016 CALIFORNIA FIRE CODE, PART 9

14. 2016 CALIFORNIA CODE, TITLE 24 CD-ROM

10. 2016 CALIFORNIA GREEN BUILDING STANDARDS CODE, PART 11 11. 2016 CALIFORNIA REFERENCED STANDARDS CODE, PART 12 12. 2016 CALIFORNIA EXISTING BUILDING CODE 13. 2016 CALIFORNIA HISTORICAL BUILDING CODE

15. 2016 CALIFORNIA TITLE 24 COMPLETE COLLECTION 16. 2016 NATIONAL ELECTRIC CODE

17. FEDERAL - OSHA

**VICINITY MAP** 



#### **SHEET INDEX**

		Sheet Issue
SHEET#	DRAWING TITLE	Date
GENERAL		
T-1.0	COVER SHEET	1/15/2019
T-1.1	OPEN SPACE ILLUSTRATIVE	1/15/2019
SITE		
T-1.2	EXISTING SITE SURVEY	1/15/2019
CIVIL		
C-1	PRELIMINARY SITE IMPROVEMENT PLAN	1/15/2019
LANDSCAPE		
L-1	PRELIMINARY LANDSCAPE PLAN	1/15/2019
SITE		
A-1.1	SITE PLAN	1/15/2019
A-1.2	SITE SECTIONS	1/15/2019
CP1	CARPORT DRAWINGS	1/15/2019
TE	TRASH ENCLOSURE	1/15/2019
ARCHITECT	URAL	
A-2.1	LEVEL 1 FLOOR PLAN	1/15/2019

1/15/2019

1/15/2019

1/15/2019

LEVEL 2 FLOOR PLAN

**EXTERIOR ELEVATIONS** 

**ROOF PLAN** 

PROJECT

**HOLLISTER VILLAGE APARTMENTS** 

7000 HOLLISTER AVE.

GOLETA, CA 93117

HOLLISTER VILLAGE

SHEET TITLE

**COVER SHEET** 

SUBMITTALS/ REVISIONS

PLANNING SUBMITTAL APPLICATION COMPLETENESS




PROJECT# PROJECT NAME

HOLLISTER VILLAGE APARTMENTS DATE DRAWN DATE 1/15/2019

SHEET NO.



OPEN SPACE ILLUSTRATIVE

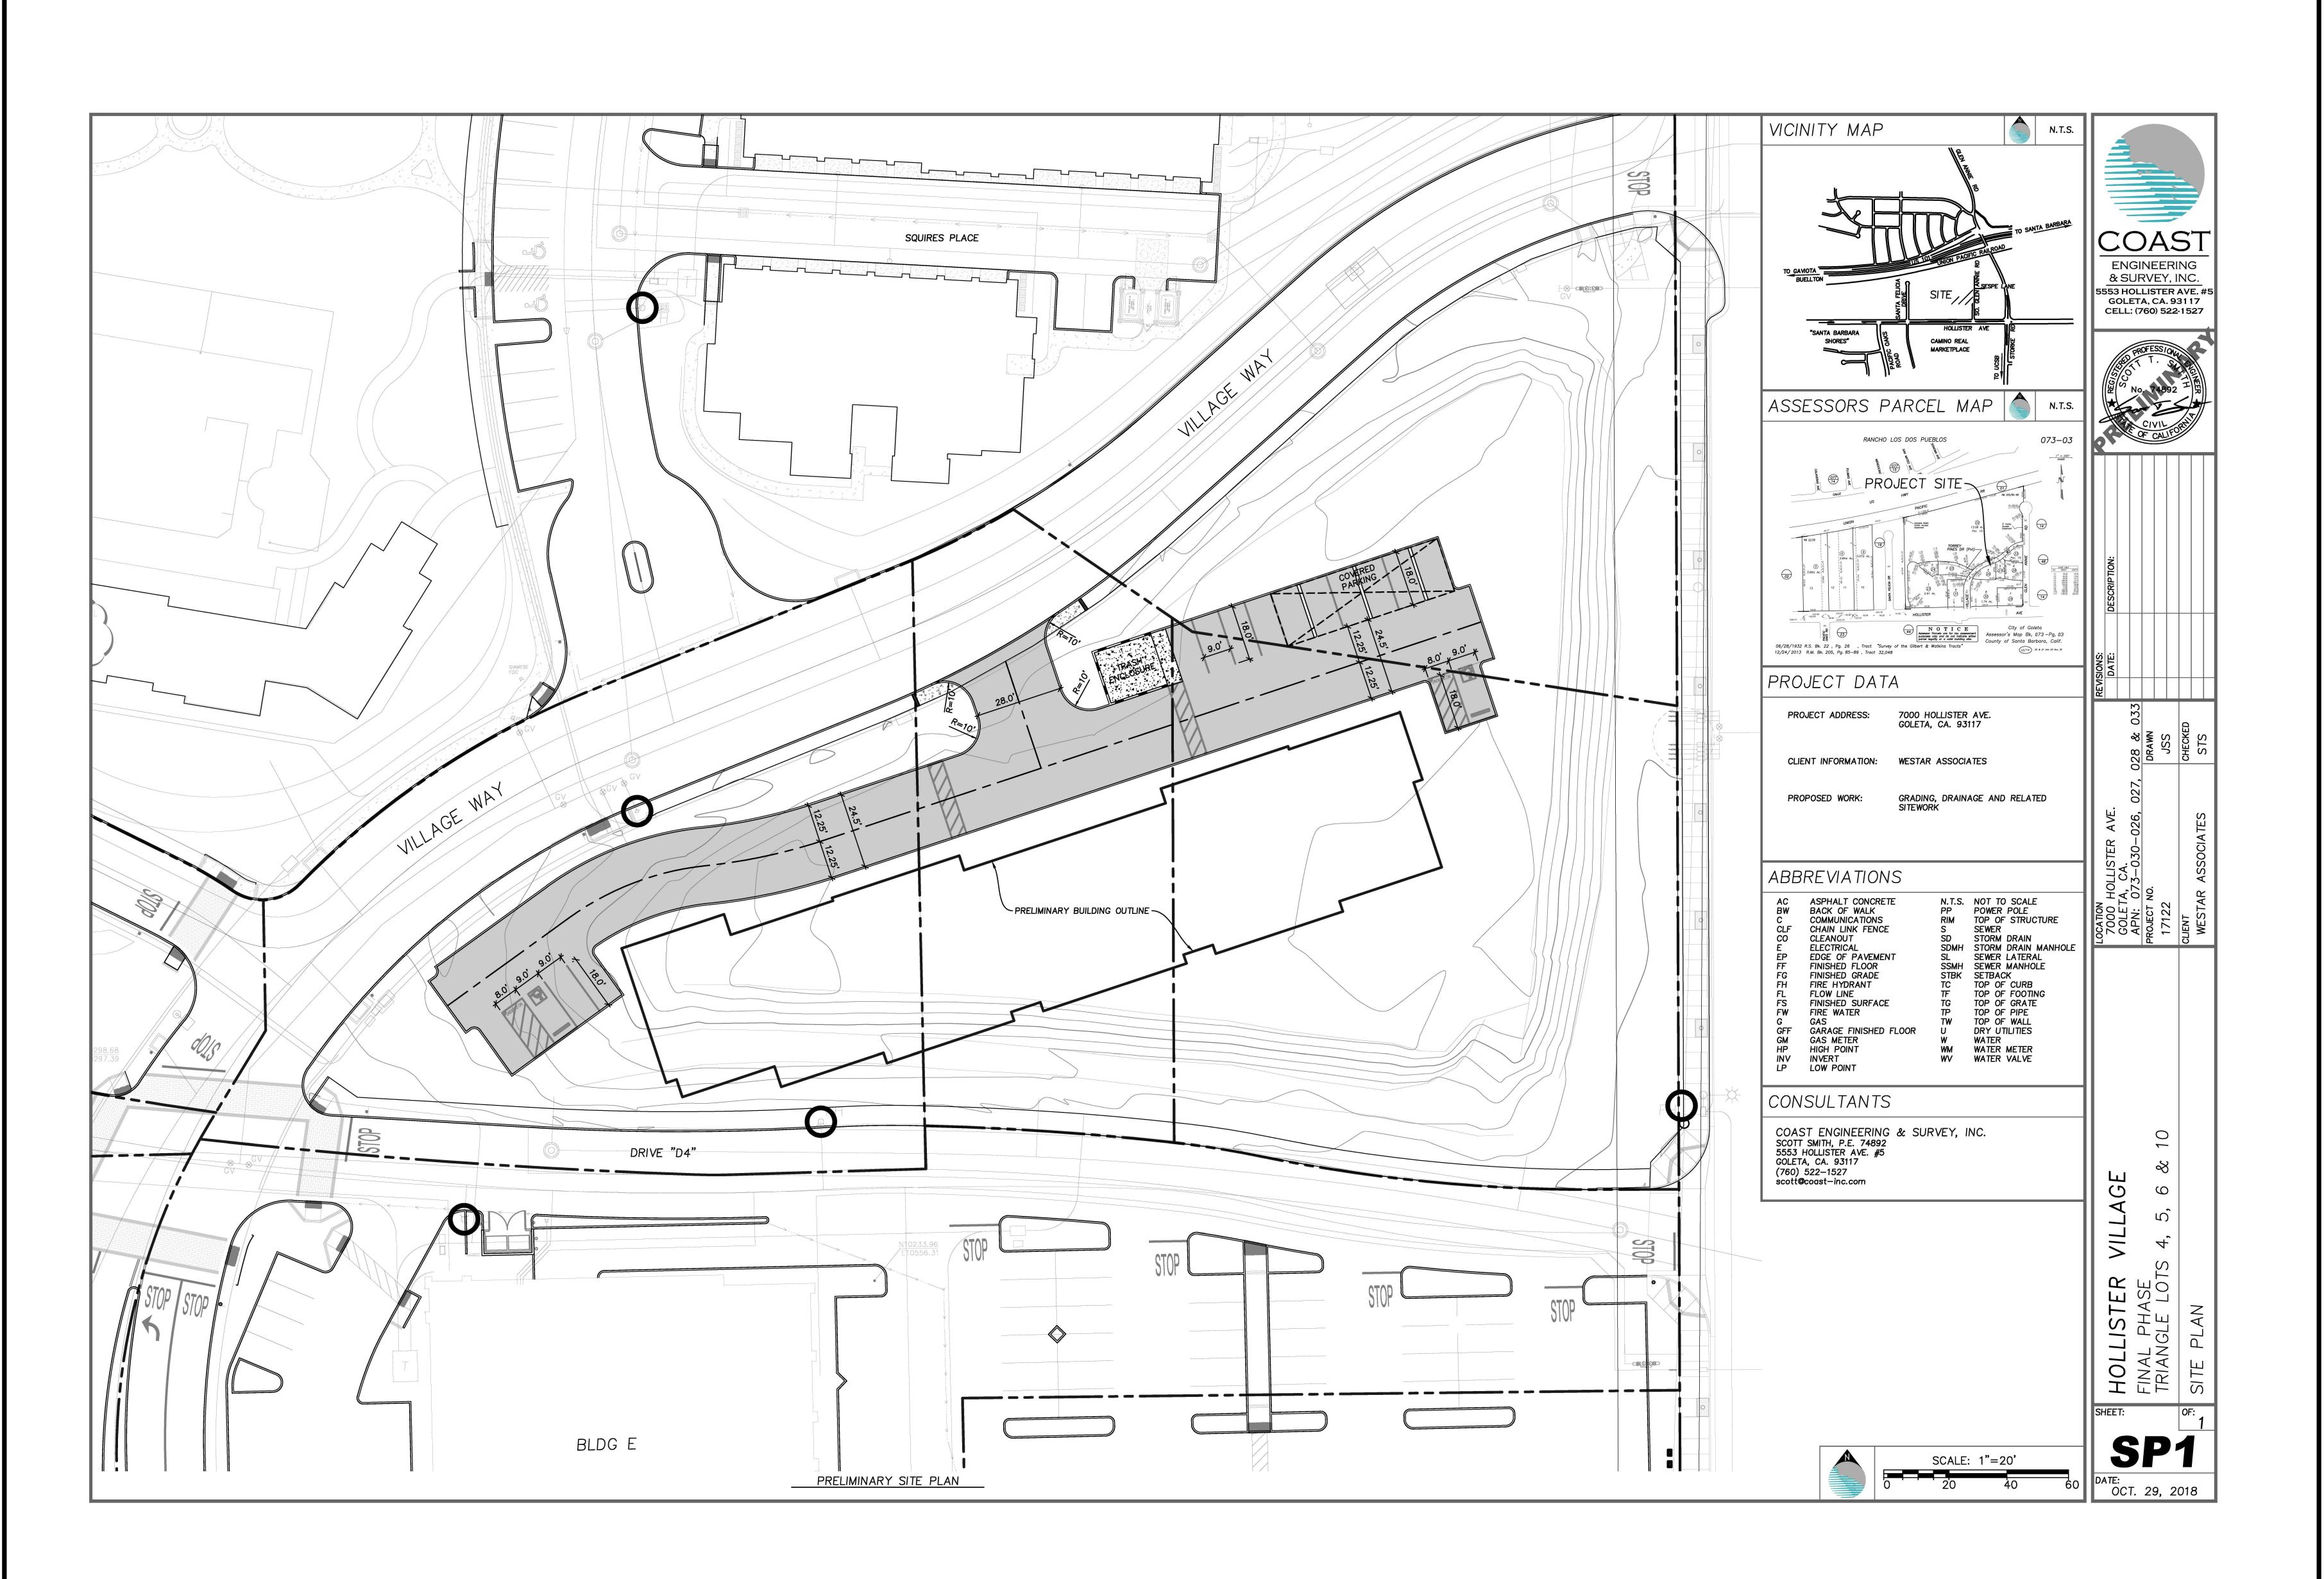

COPYIRIGHT.

2017 BY THOMAS OCHSNER.

ALL RIGHTS RESERVED.

NO PART OF THIS DRAWING MAY

BE

REPRODUCED.



THOMAS OCHSNER Architect

Thomas
Ochsner AIA

10 E. Yanonali Street
Suite 2D
Santa Barbara, CA
93101
Tel 805.770.7576
Cel 805.705.6558
tom@toarchitect.com

www.toarchitect.com

CLIENT

WESTAR ASSOCIATES

PROJECT

HOLLISTER VILLAGE APARTMENTS

7000 HOLLISTER AVE. GOLETA, CA 93117

HOLLISTER VILLAGE

SHEET TITLE

EXISTING SITE SURVEY

SUBMITTALS/ REVISIONS

PLANNING SUBMITTAL

APPLICATION COMPLETENESS 1/1:



PROJECT #


PROJECT NAME

HOLLISTER VILLAGE APARTMENTS


DATE DRAWN

DATE 1/15/2019
SHEET NO.

T-1.2

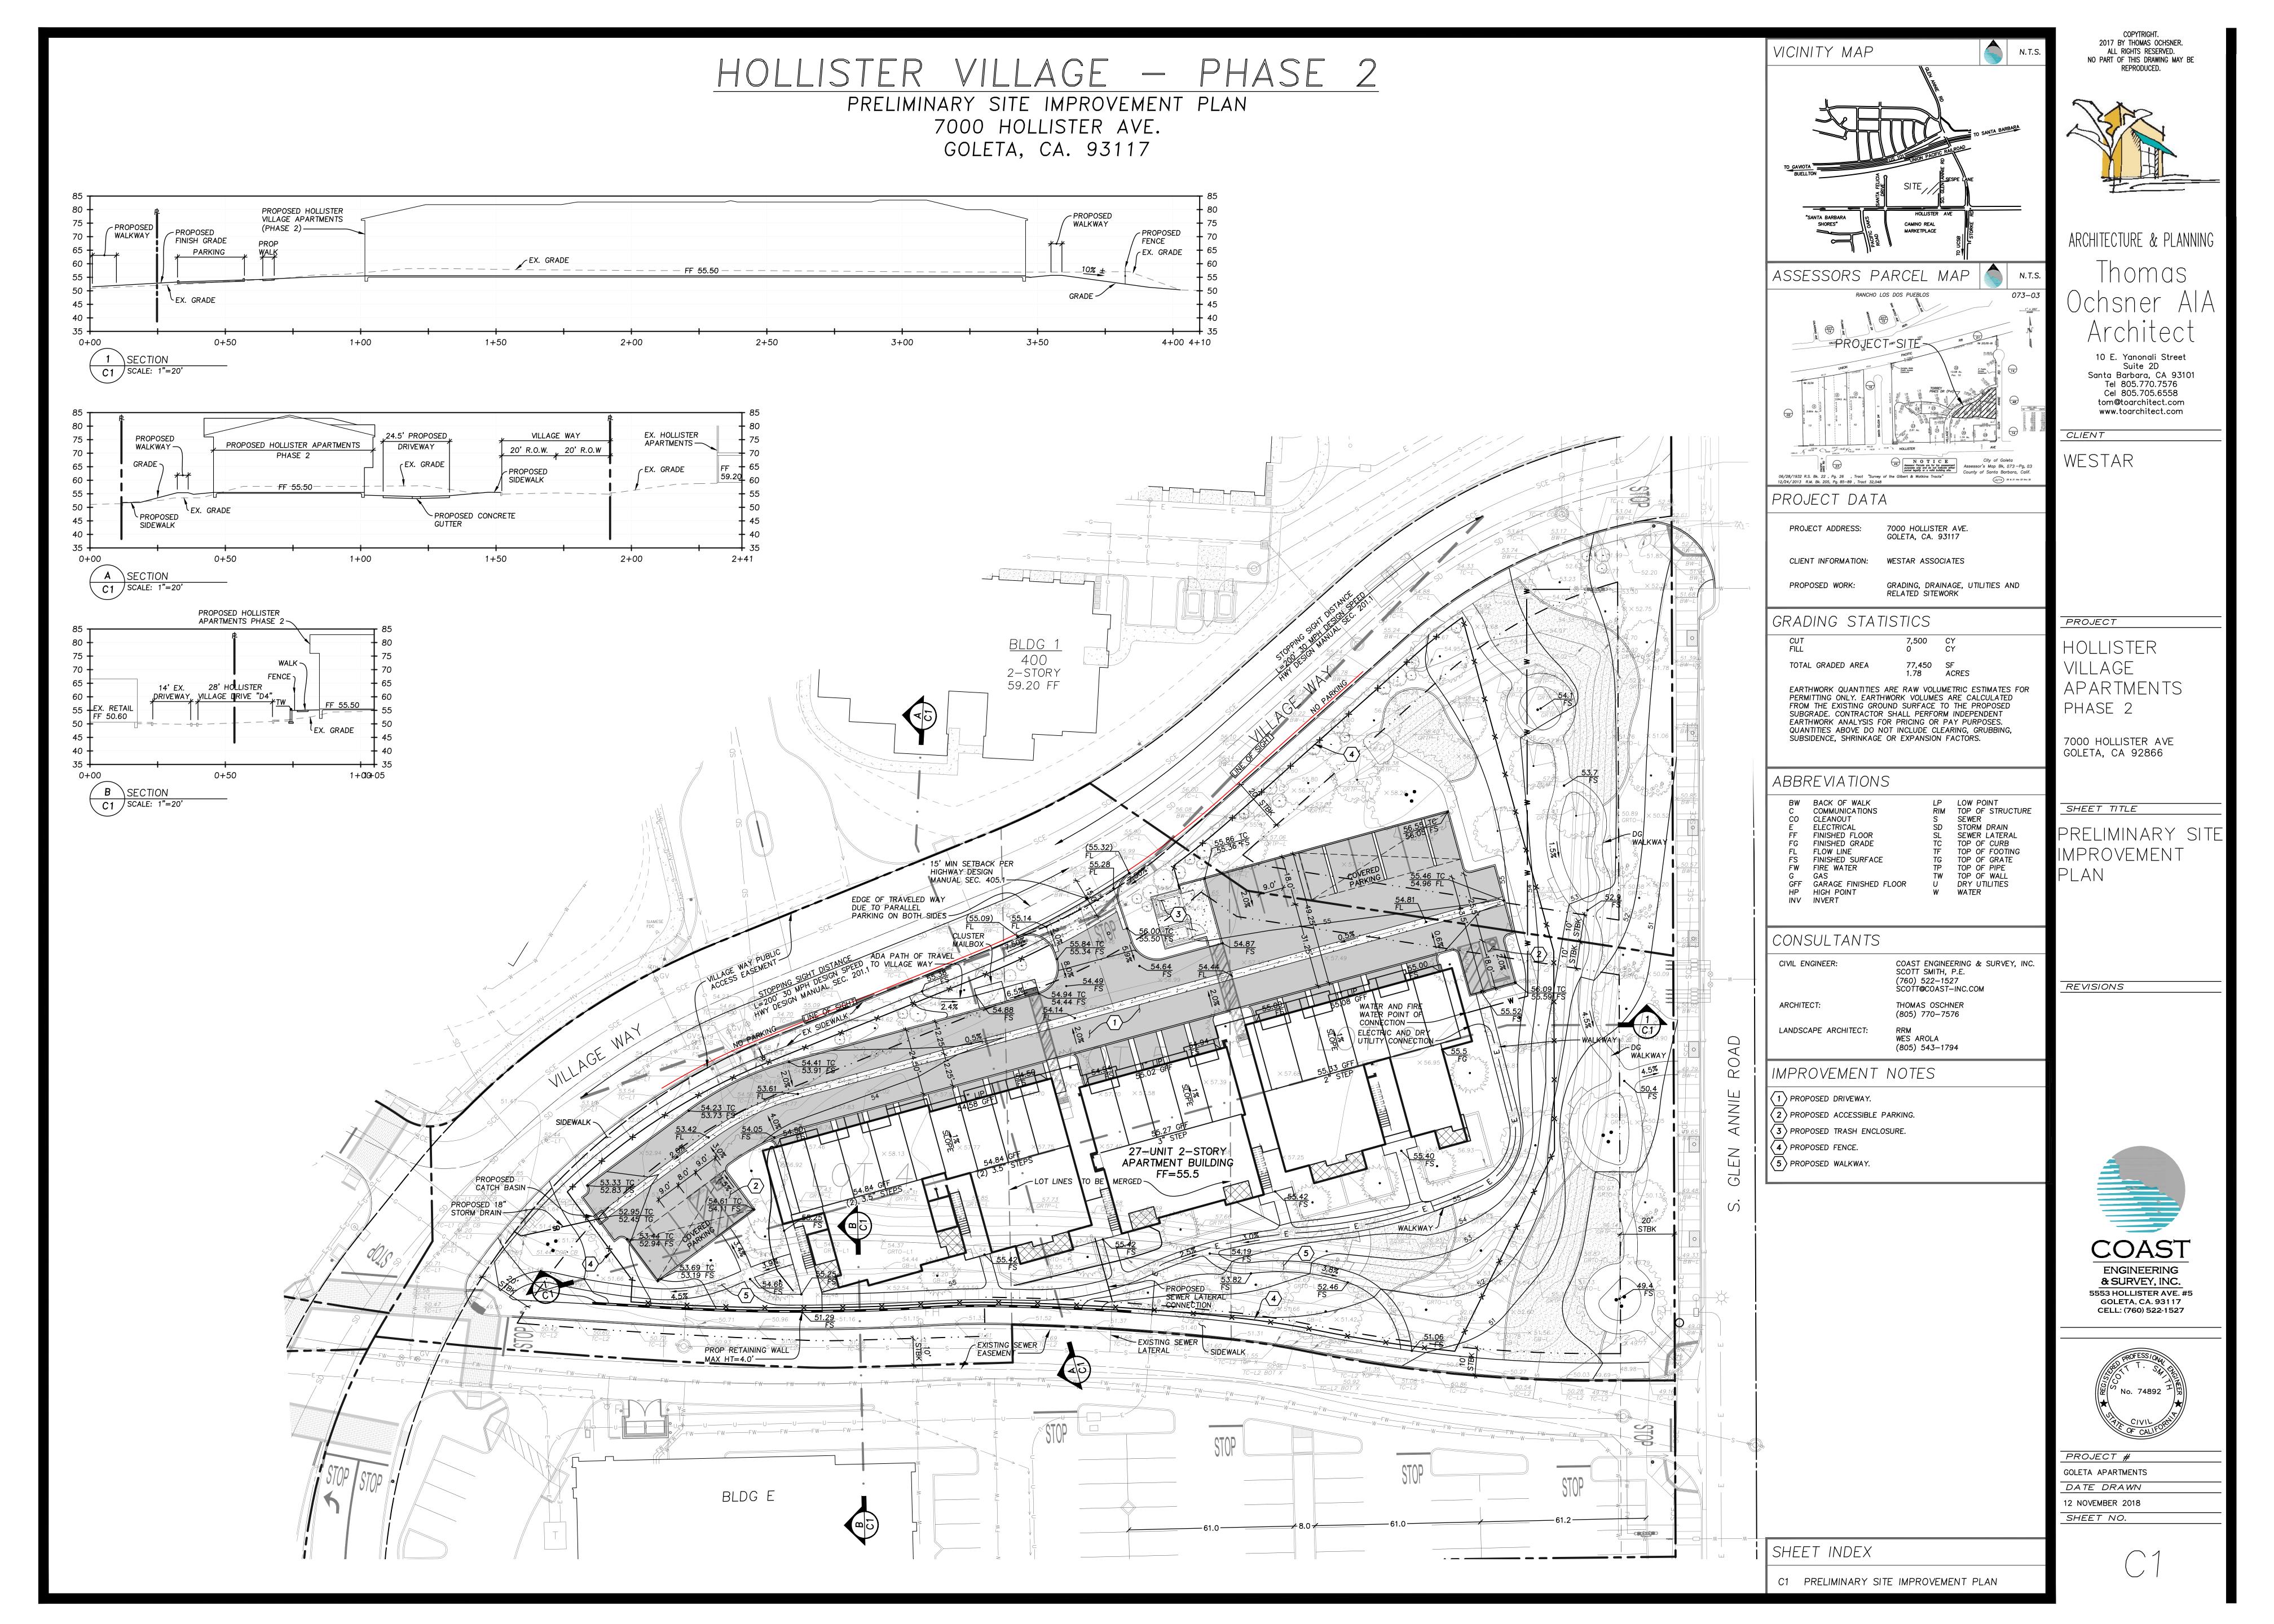

#### PRELIMINARY PLANT LIST:

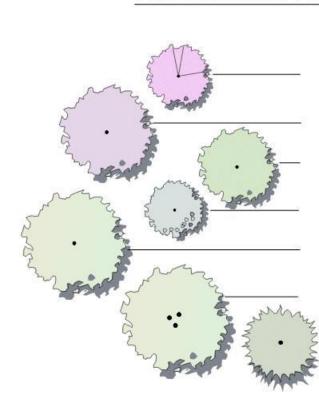

TREES COMMON NAME CONT CHORISIA SPECIOSA SILK FLOSS TREE 24"BOX 24" BOX JACARANDA MIMOSIFOLIA **JACARANDA** KOELREUTERIA PANICULATA **GOLDEN RAIN TREE** 24"BOX OLEA EUROPAEA `WILSONII` WILSON OLIVE 48"BOX PLATANUS RACEMOSA LONDON PLANE TREE 24"BOX QUERCUS AGRIFOLIA COAST LIVE OAK 48"BOX

15 GAL TRISTANIA CONFERTA BRISBANE BOX CONT COMMON NAME ALOE STRIATA CORAL ALOE 5 GAL ALYOGYNE HUEGELII `SANTA CRUZ` **BLUE HIBISCUS** 5 GAL BIG RED KANGAROO PAW 1 GAL ANIGOZANTHOS SPP. 1 GAL STALKED BULBINE BULBINE FRUTESCENS 'HALLMARK' CHONDROPETALUM TECTORUM 'EL CAMPO' 1 GAL CAPE RUSH 1 GAL DIANELLA CAERULEA 'CASSA BLUE' CASSA BLUE FLAX LILY 1 GAL FICUS REPENS CREEPING FIG 1 GAL JUNCUS SPP. LAVANDULA X INTERMEDIA `PROVENCE` PROVENCE LAVENDIN 1 GAL 1 GAL TROPIC BELLE MAT RUSH LOMANDRA HYSTRIX 'TROPIC BELLE' LOMANDRA LONGIFOLIA `BREEZE` DWARF MAT RUSH 1 GAL OLEA EUROPAEA `LITTLE OLLIE` TM LITTLE OLLIE OLIVE 5 GAL 5 GAL PHLOMIS FRUTICOSA JERUSALEM SAGE 5 GAL PHORMIUM SPP. **NEW ZEALAND FLAX** 5 GAL PITTOSPORUM SPP. **TAWHIWHI** 1 GAL ROSMARINUS SPP. ROSEMARY SALVIA GREGGII **AUTUMN SAGE** 1 GAL SEDUM X 'AUTUMN JOY' AUTUMN JOY SEDUM 1 GAL 1 GAL SENECIO MANDRALISCAE **BLUE FINGER** SESLERIA AUTUMNALIS **AUTUMN MOOR GRASS** 1 GAL

#### IRRIGATION AND PLANTING DESIGN CRITERIA:

A WEATHER SENSING, 'SMART CONTROLLER' WILL BE USED TO MONITOR THE IRRIGATION WATER AND MANAGE DAILY WATER CONSUMPTION TO THE MINIMUM REQUIREMENTS FOR EACH HYDROZONE.

ALL TREES, POTTERY, SHRUB AND GROUNDCOVER AREAS WILL BE IRRIGATED ON SEPARATE HYDROZONES, SO THAT ONCE ESTABLISHED, WATER CAN BE REGULATED IN A MORE EFFICIENT MANNER.

TREES AND POTTERY WILL BE IRRIGATED BY BUBBLERS. ALL PLANTING WILL RECEIVE DRIP IRRIGATION.

ALL ABOVE GROUND UTILITIES WILL BE SCREEN WITH VEGETATION.

I CERTIFY THAT THIS PLANT PALETTE COUPLED WITH THE IRRIGATION DESCRIBED ABOVE WILL MEET OR EXCEED THE STATE MODEL WATER

LANDSCAPE ARCHITECT | CA LICENSE NUMBER #5958

EFFICIENT LANDSCAPE ORDINANCE (MWELO)

WESLEY AROLA

#### DESIGN KEY:

- 1) DECOMPOSED GRANITE PATH
- 2 OPEN FENCING WITH PEDESTRIAN GATES
- 3 BENCH SEATING, TYP
- 4 PASSIVE LAWN AREA
- 5 SIGNATURE TREE
- 6 MAIL BOX
- 7 VEGETATIVE SCREENING (SHOWN SCHEMATICALLY)

8 GENERAL PLANTING AREAS OF SHRUBS AND GROUNDCOVER (NOT LAWN, SEE PLANT LIST AT RIGHT)

DEVELOPMENT

LANDSCAPE DESIGN NOTE:

IT IS THE INTENT THAT ALL MATERIALS AND BUILT ELEMENTS

COMPLIMENT AND CORRESPOND WITH THE EXISTING

PROJECT

HOLLISTER VILLAGE APARTMENTS PHASE 2

7000 HOLLISTER AVE GOLETA, CA 92866

SHEET TITLE

LANDSCAPE PLAN

REVISIONS

**GRAPHIC SCALE** ( In Feet ) 1/16 inch = 1 foot

COPYTRIGHT. 2017 BY THOMAS OCHSNER. ALL RIGHTS RESERVED. NO PART OF THIS DRAWING MAY BE REPRODUCED.



ARCHITECTURE & PLANNING


10 E. Yanonali Street Suite 2D Santa Barbara, CA 93101 Tel 805.770.7576 Cel 805.705.6558 tom@toarchitect.com www.toarchitect.com


CLIENT

WESTAR

PROJECT # GOLETA APARTMENTS DATE DRAWN 15 JANUARY 2019 SHEET NO.

L-1.0

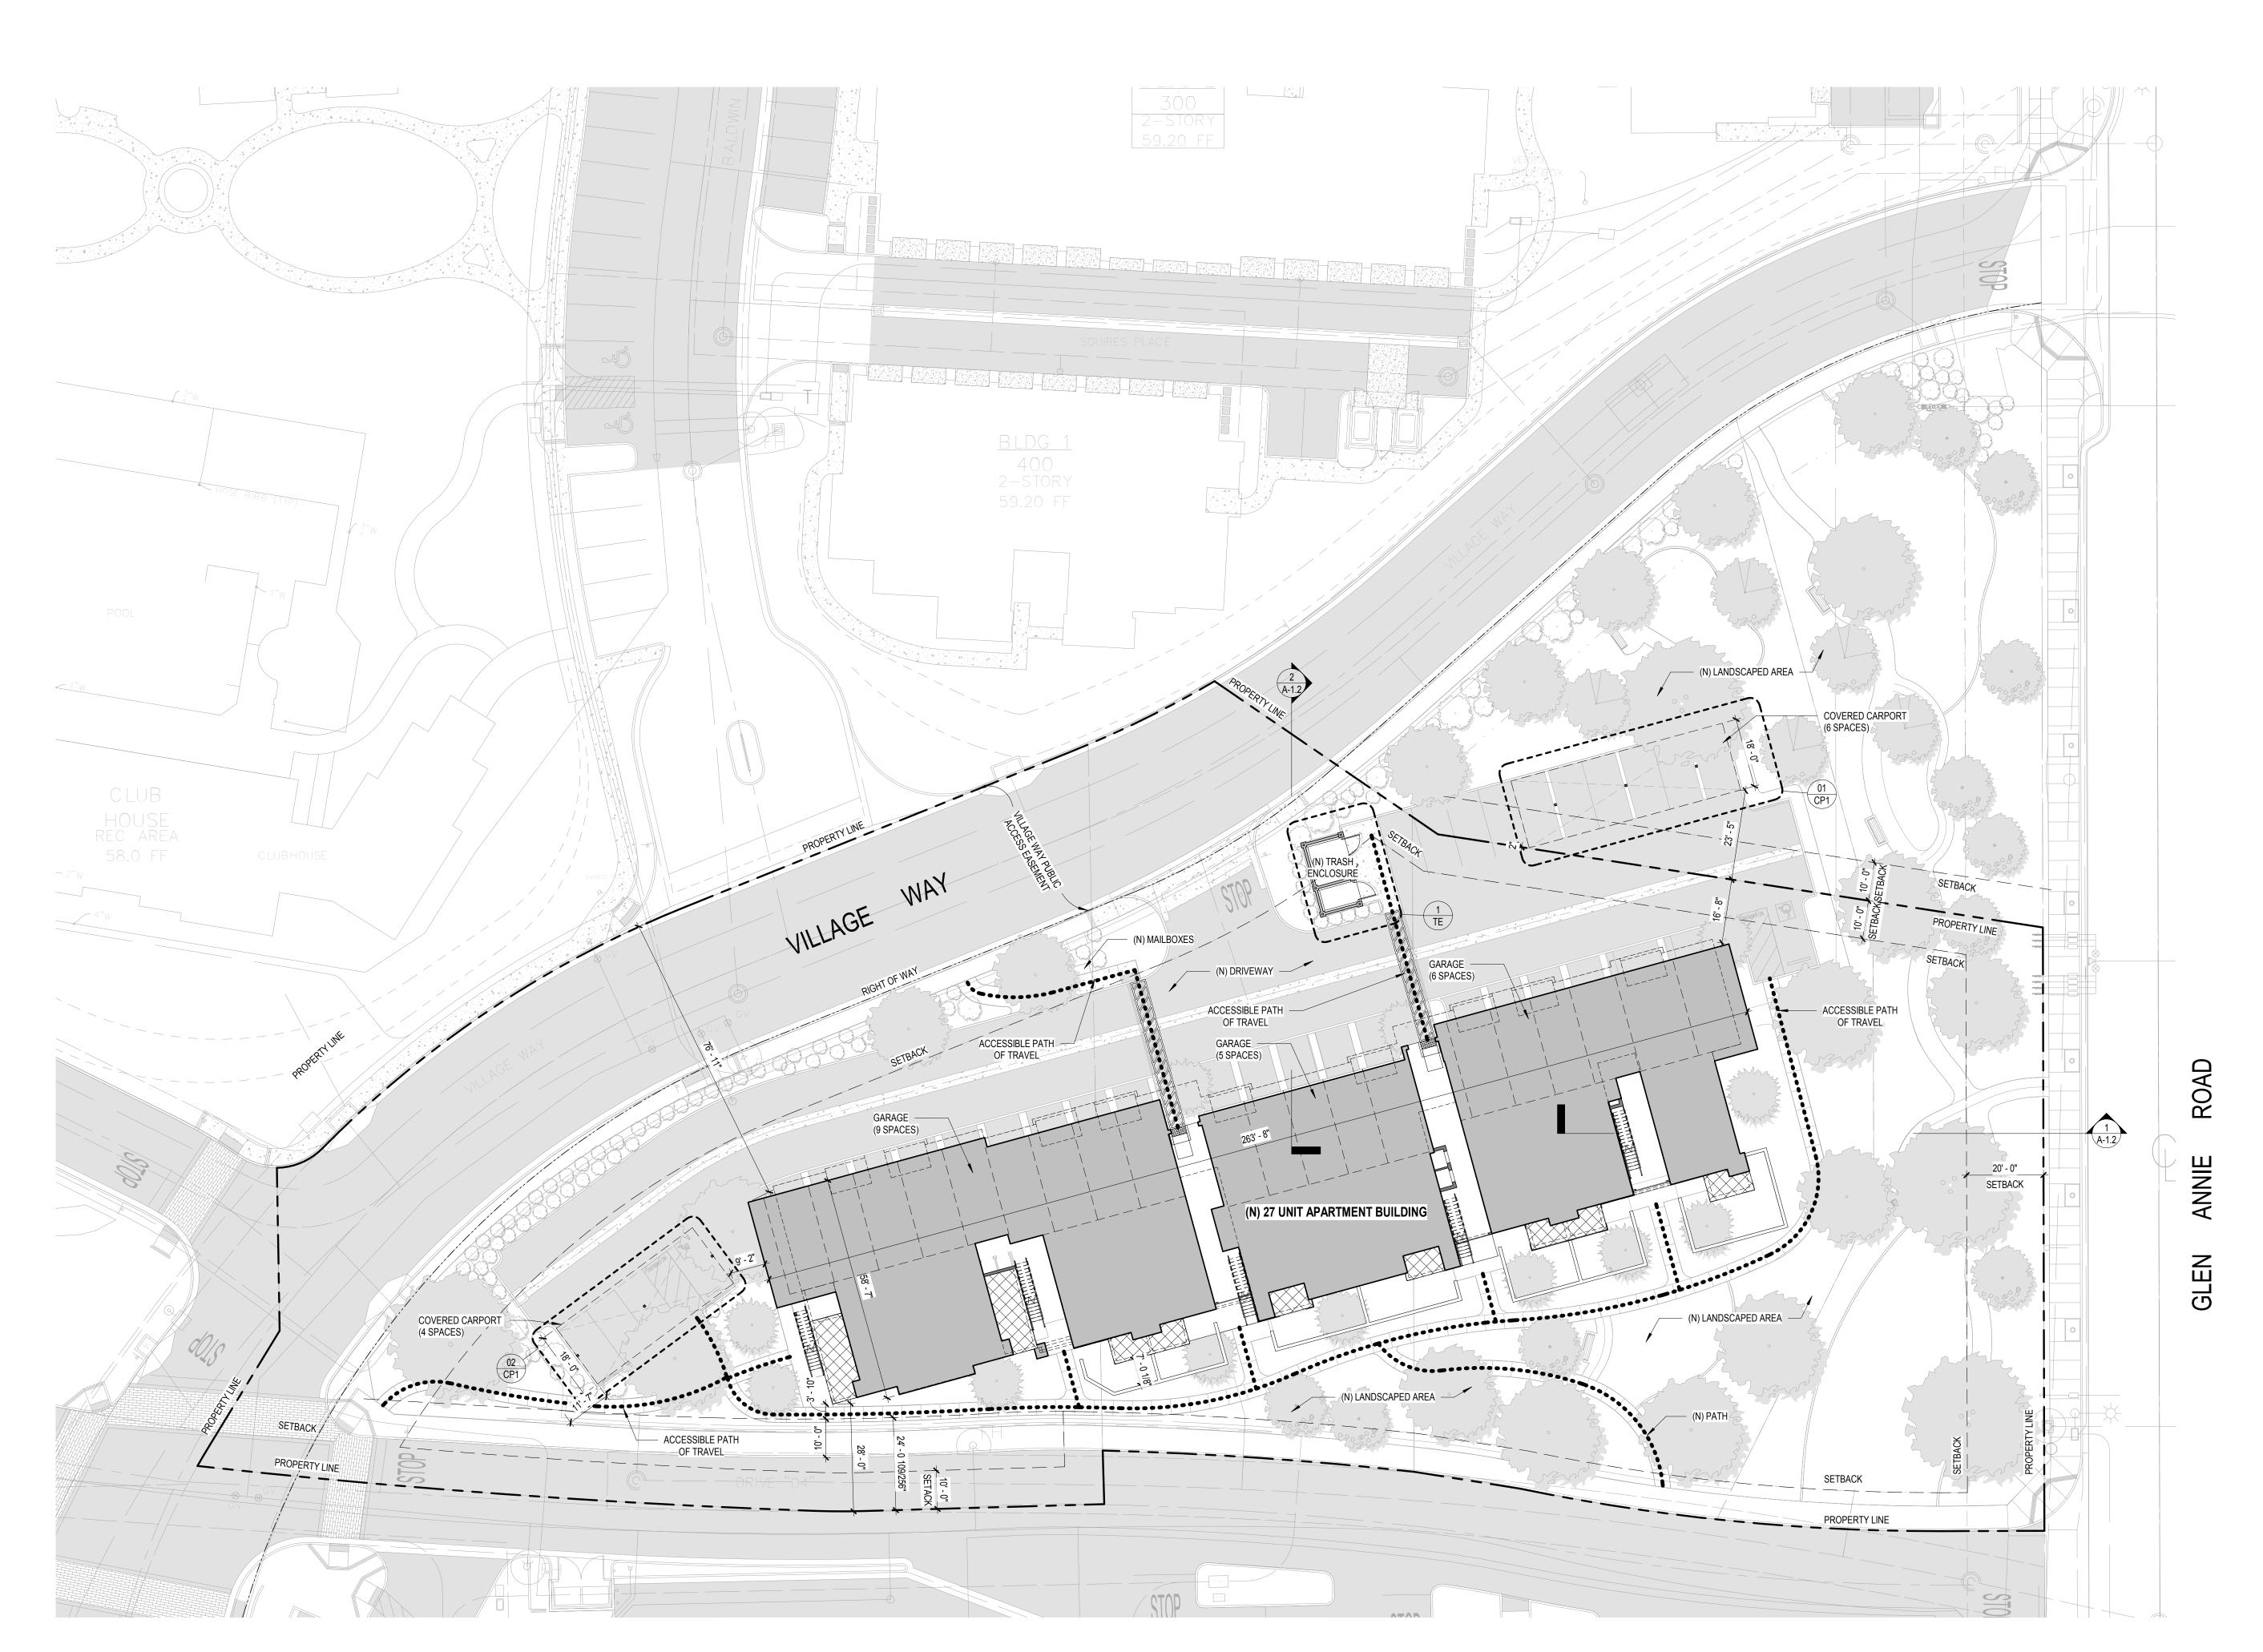

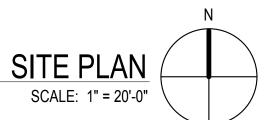

#### GENERAL NOTES - GRADING

1. ALL GRADING SHALL CONFORM WITH SANTA BARBARA COUNTY CODE CHAPTER 14 GRADING ORDINANCE #4477 AND STANDARDS AND REQUIREMENTS PERTAINING THERETO, THESE CONSTRUCTION DRAWINGS AND THE RECOMMENDATIONS OF THE SOILS ENGINEER AND ENGINEERING GEOLOGIST.

CONTRACTOR TO NOTIFY THE COUNTY GRADING INSPECTOR AND SOILS LABORATORY AT LEAST **48 HOURS** BEFORE START OF GRADING WORK OR PRE-CONSTRUCTION MEETING. CONTRACTOR SHALL EMPLOY ALL LABOR, EQUIPMENT AND METHODS REQUIRED TO PREVENT HIS OPERATIONS FROM PRODUCING DUST IN AMOUNTS DAMAGING TO ADJACENT PROPERTY, CULTIVATED VEGETATION AND DOMESTIC ANIMALS OR CAUSING A NUISANCE TO PERSONS OCCUPYING BUILDINGS IN THE VICINITY OF THE JOB SITE. CONTRACTOR SHALL BE RESPONSIBLE FOR DAMAGE CAUSED BY DUST FROM HIS GRADING OPERATION.

4. BEFORE BEGINNING WORK REQUIRING EXPORTING OR IMPORTING OF MATERIALS, THE CONTRACTOR SHALL OBTAIN APPROVAL FROM THE PUBLIC WORKS ROAD DIVISION FOR HAUL ROUTES USED AND METHODS PROVIDED TO MINIMIZE THE DEPOSIT OF SOILS ON COUNTY ROADS. GRADING/ROAD INSPECTORS SHALL MONITOR THIS REQUIREMENT WITH THE CONTRACTOR.

5. THE GEOTECHNICAL ENGINEER SHALL PROVIDE OBSERVATION AND TESTING DURING GRADING OPERATIONS IN THE FIELD AND SHALL SUBMIT A FINAL REPORT STATING THAT ALL EARTH WORK WAS PROPERLY COMPLETED AND IS IN SUBSTANTIAL CONFORMANCE WITH THE REQUIREMENTS OF THE GRADING ORDINANCE.

6. AREAS TO BE GRADED SHALL BE CLEARED OF ALL VEGETATION INCLUDING ROOTS AND OTHER UNSUITABLE MATERIAL FOR A STRUCTURAL FILL, THEN SCARIFIED TO A DEPTH OF 6" PRIOR TO PLACING OF ANY FILL. CALL GRADING INSPECTOR FOR INITIAL INSPECTION.

7. A THOROUGH SEARCH SHALL BE MADE FOR ALL ABANDONED MAN-MADE FACILITIES SUCH AS SEPTIC TANK SYSTEMS, FUEL OR WATER STORAGE TANKS, AND PIPELINES OR CONDUITS. ANY SUCH FACILITIES ENCOUNTERED SHALL BE REMOVED AND THE DEPRESSION PROPERLY FILLED AND COMPACTED UNDER OBSERVATION OF THE GEOTECHNICAL ENGINEER.

8. AREAS WITH EXISTING SLOPES WHICH ARE TO RECEIVE FILL MATERIAL SHALL BE KEYED AND BENCHED. THE DESIGN AND INSTALLATION OF THE KEYWAY SHALL BE PER THE GEOTECHNICAL ENGINEER'S RECOMMENDATION OR PER COUNTY STANDARD DETAIL NO. G-13.

9. FILL MATERIAL SHALL BE SPREAD IN LIFTS NOT EXCEEDING 6" IN COMPACTED THICKNESS, MOISTENED OR DRIED AS NECESSARY TO NEAR OPTIMUM MOISTURE CONTENT AND COMPACTED BY AN APPROVED METHOD. FILL MATERIAL SHALL BE COMPACTED TO A MINIMUM OF 90% MAXIMUM DENSITY AS DETERMINED BY 1957 ASTM D - 1557 - 91 MODIFIED PROCTOR AASHO) TEST OR SIMILAR APPROVED METHODS. SOME FILL AREAS MAY REQUIRE COMPACTION TO A GREATER DENSITY IF CALLED FOR IN THE CONSTRUCTION DOCUMENTS. SOIL TESTS SHALL BE CONDUCTED AT NOT LESS THAN ONE TEST FOR EACH 18" OF FILL AND/OR FOR EACH 500 CUBIC YARDS OF FILL PLACED.

COMBINATION FILL AND CUT SLOPES SHALL NOT EXCEED 2-HORIZONTAL TO 1-VERTICAL. SLOPES OVER 3-FEET IN VERTICAL HEIGHT SHALL BE PLANTED WITH APPROVED PERENNIAL VEGETATION OR TREATED WITH EQUALLY APPROVED EROSION CONTROL MEASURES PRIOR TO FINAL INSPECTION.

10. CUT SLOPES SHALL NOT EXCEED A GRADE OF 11/2-HORIZONTAL TO 1-VERTICAL. FILL AND

11. SURFACE DRAINAGE SHALL BE PROVIDED AT A MINIMUM OF 2% FOR 5 FEET AWAY FROM THE FOUNDATION LINE OR ANY STRUCTURE.

PROTECTED AROUND THE DRIP LINE DURING GRADING OPERATION.

12. ALL TREES THAT ARE TO REMAIN ON SITE SHALL BE TEMPORARILY FENCED AND

13. AN EROSION AND SEDIMENT CONTROL PLAN SHALL BE REQUIRED AS PART OF THE GRADING PLAN AND PERMIT REQUIREMENTS.

#### KEYNOTES

OCCUPANCY

X.XX KEYNOTE DESIGNATION

KEYNOTE TEXT

#### PROJECT DATA

OWNER: GOLETA HOLLISTER APARTMENTS LLC C/O WESTAR ASSOCIATES 2925 BRISTOL STREET COSTA MESA, CA 92626

A.P.N. 073-030-026 PROJECT ADDRESS: 7000 HOLLISTER AVE. GOLETA, CA 93117 GENERAL PLAN: R-M-D DR-20 ZONE:

GARAGES, U CARPORTS LOT SIZE: 1.42 ACRES, 61,855 SF

R-2 APARTMENTS, S-2

TYPE OF CONSTRUCTION: V-A 1 HOUR PROPOSED NUMBER OF STORIES:


27'-8" PROPOSED BUILDING HEIGHT: PROPOSED MEAN BLDG HEIGHT: 25'-6" SPRINKLERS: YES, NFPA 13R

HIGH FIRE: **BUILDING COVERAGE:** 14,764 SF\*

( \* BUILDING COVERAGE NUMBER FOR 1.42 ACRE LOT ONLY)

#### **BUILDING NET AREA**

R-2 RESIDENTIAL: 16,452 SF S-2 GARAGE: 5,589 SF U STORAGE/ UTILITY 364 SF 22,405 SF TOTAL

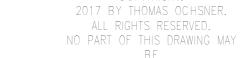



REPRODUCED.

THOMAS OCHSNER Architect

ARCHITECTURE & PLANNING

# Thomas Ochsner AIA Architect

10 E. Yanonali Street Suite 2D Santa Barbara, CA Tel 805.770.7576 Cel 805.705.6558 tom@toarchitect.com www.toarchitect.com

CLIENT

WESTAR ASSOCIATES

PROJECT

#### HOLLISTER **VILLAGE APARTMENTS**

7000 HOLLISTER AVE. GOLETA, CA 93117

HOLLISTER VILLAGE

SHEET TITLE

SITE PLAN

SUBMITTALS/ REVISIONS

PLANNING SUBMITTAL APPLICATION COMPLETENESS





PROJECT# PROJECT NAME

HOLLISTER VILLAGE APARTMENTS

DATE 1/15/2019 SHEET NO.

DATE DRAWN

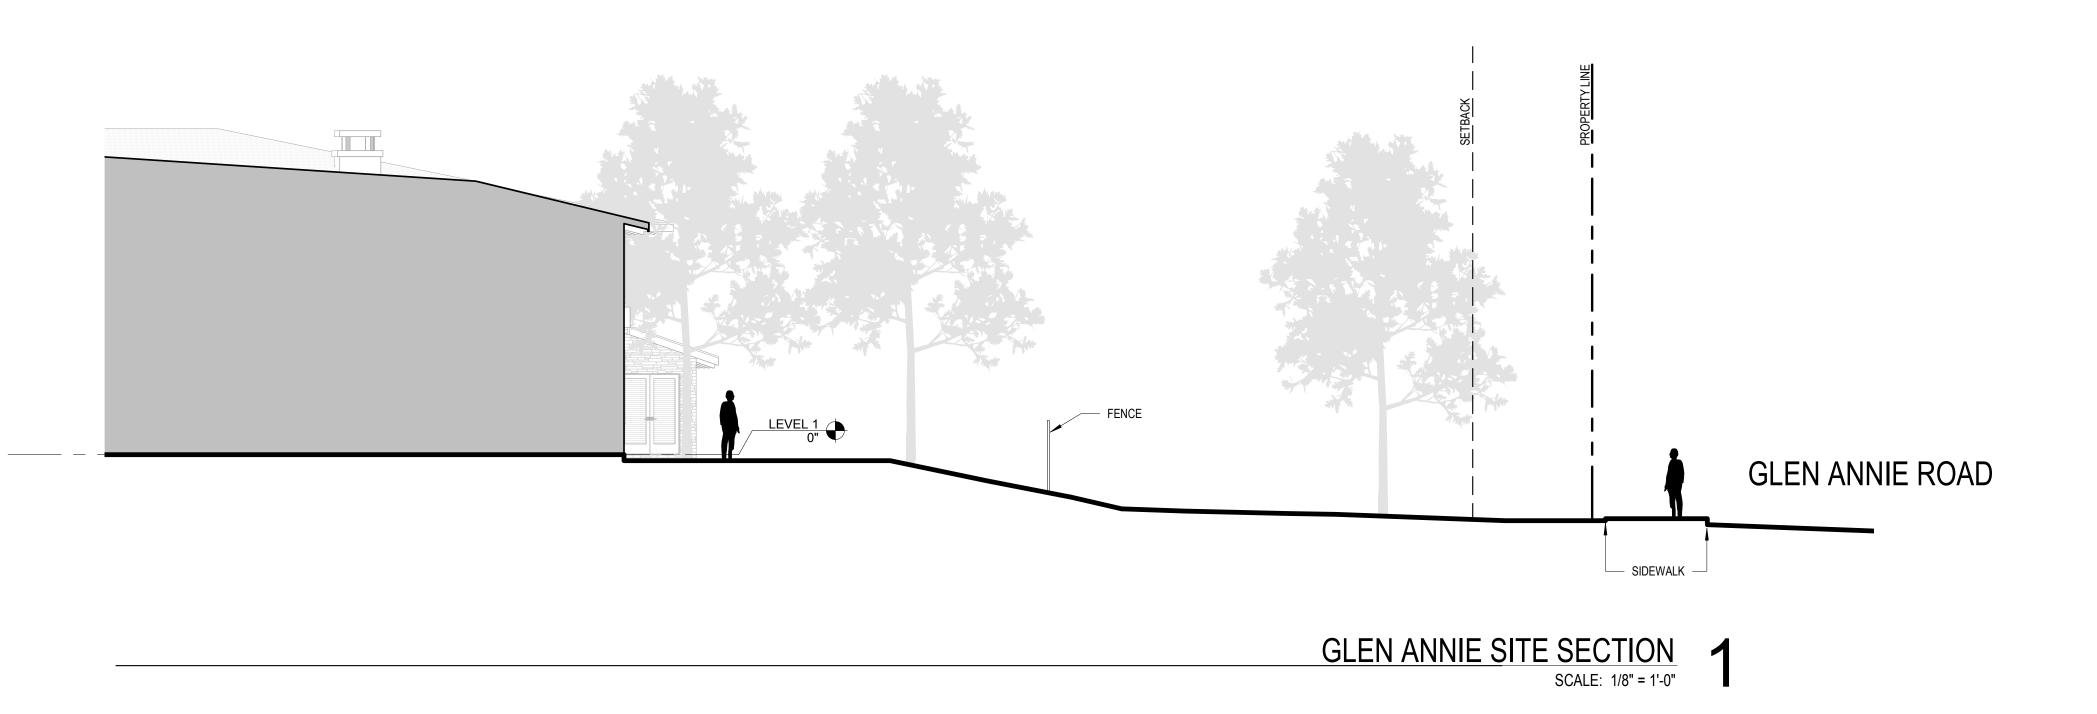

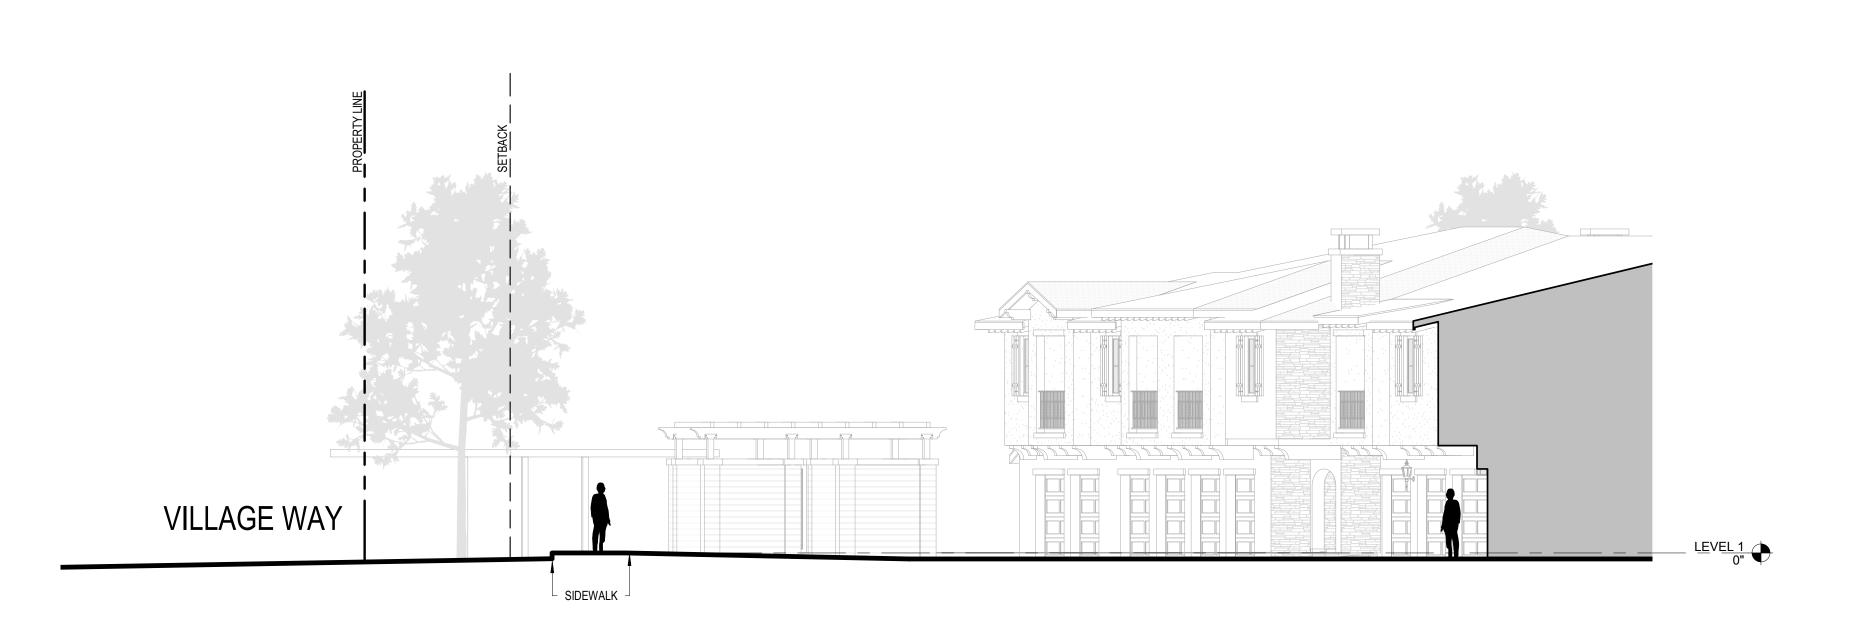

VILLAGE WAY SITE SECTION
SCALE: 1/8" = 1'-0"

COPYTRIGHT.
2017 BY THOMAS OCHSNER.
ALL RIGHTS RESERVED.
NO PART OF THIS DRAWING MAY
BE
REPRODUCED.



THOMAS OCHSNER Architect

ARCHITECTURE & PLANNING

## Thomas Ochsner Ala Architect 10 E. Yanonali Street Suite 2D Santa Barbara, CA 93101 Tel 805.770.7576 Cel 805.705.6558 tom@toarchitect.com www.toarchitect.com

CLIENT

WESTAR **ASSOCIATES** 

PROJECT

HOLLISTER VILLAGE **APARTMENTS** 

7000 HOLLISTER AVE. GOLETA, CA 93117

HOLLISTER VILLAGE

SHEET TITLE

SITE SECTIONS


SUBMITTALS/ REVISIONS

APPLICATION COMPLETENESS 1/15/2019




PROJECT# PROJECT NAME HOLLISTER VILLAGE APARTMENTS DATE DRAWN


DATE 1/15/2019 SHEET NO.

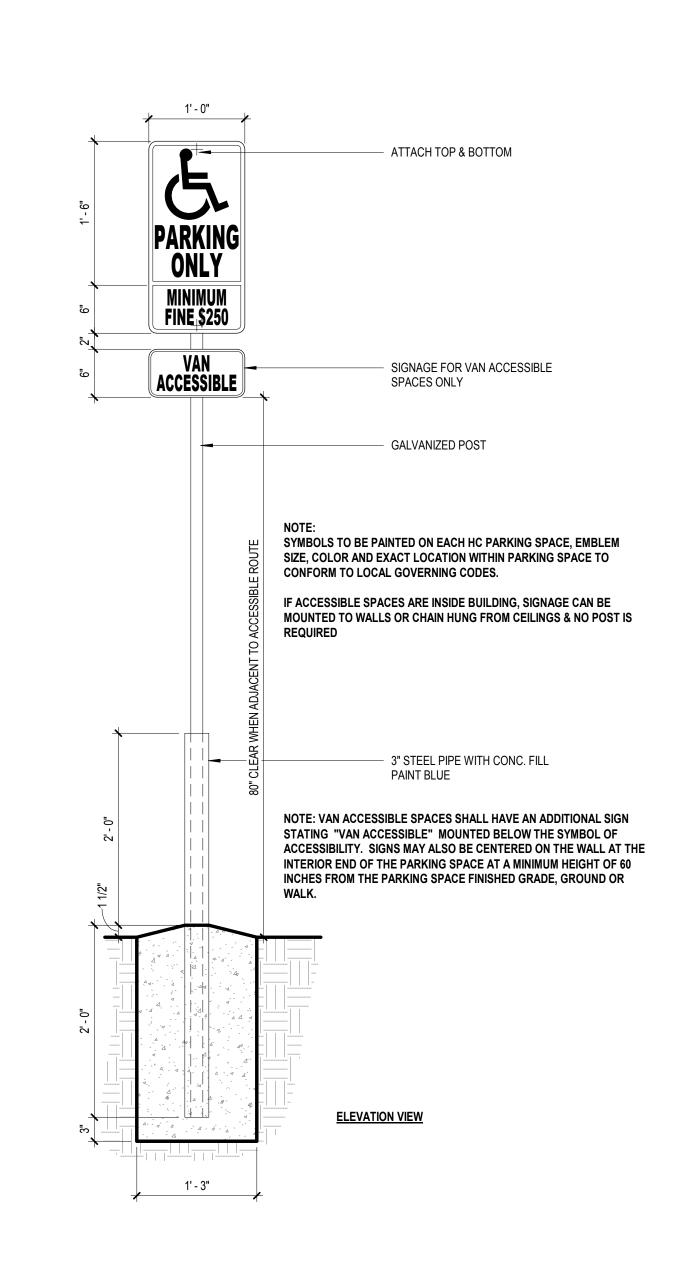



PARKING SIGNAGE SCALE: 1" = 1'-0"

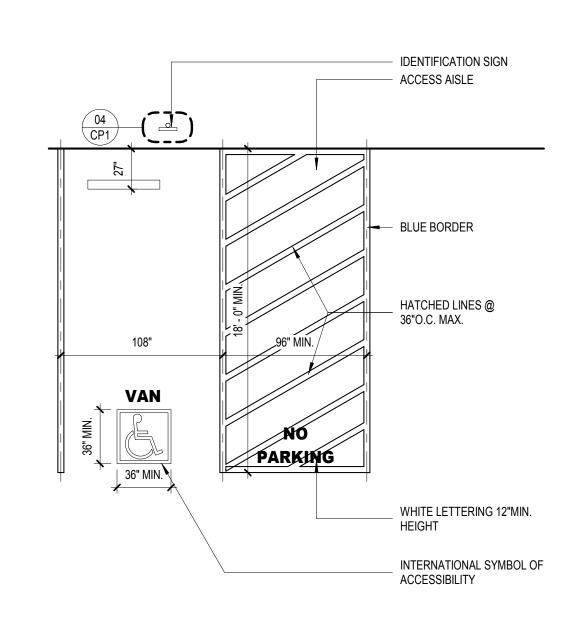

PARKING SPACE 05
SCALE: 3/16" = 1'-0"

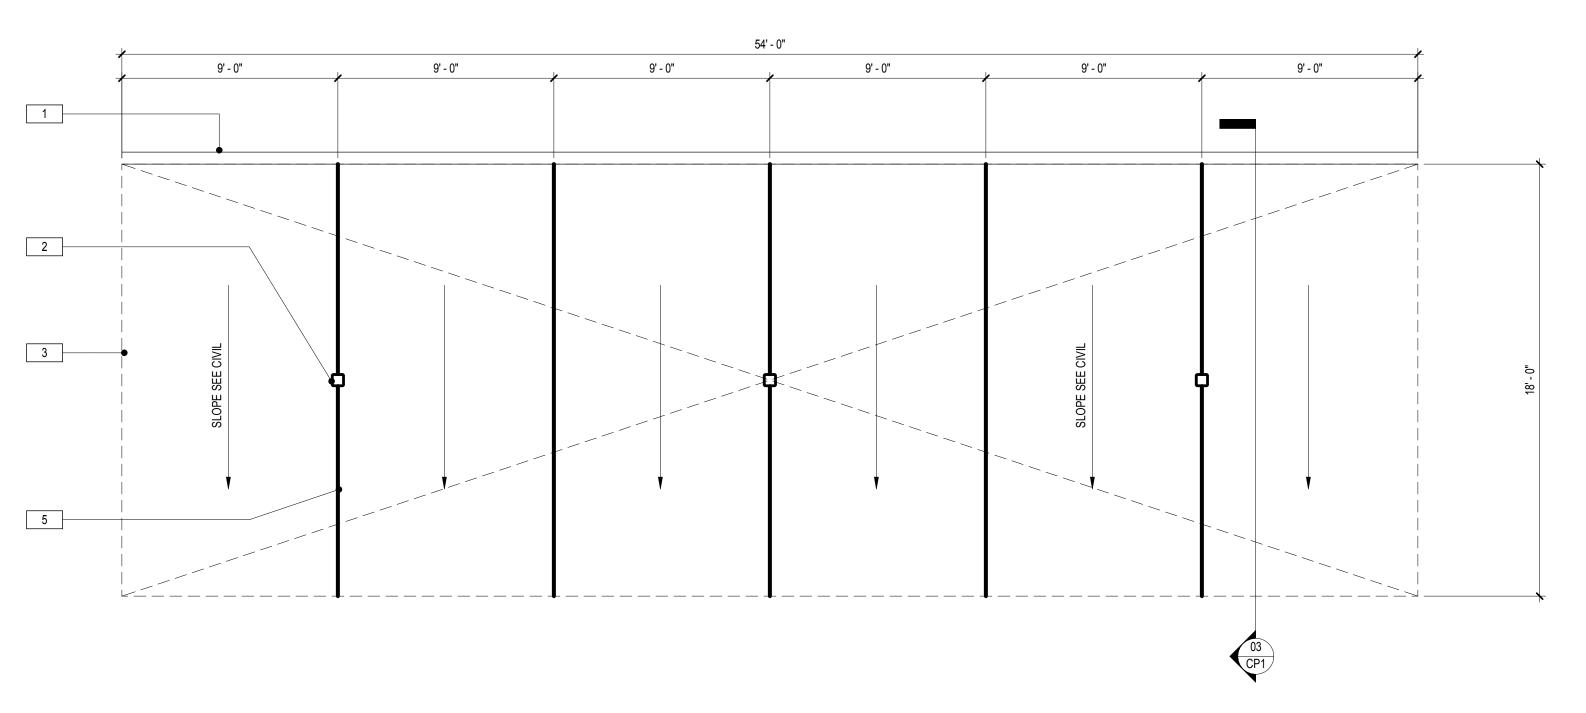

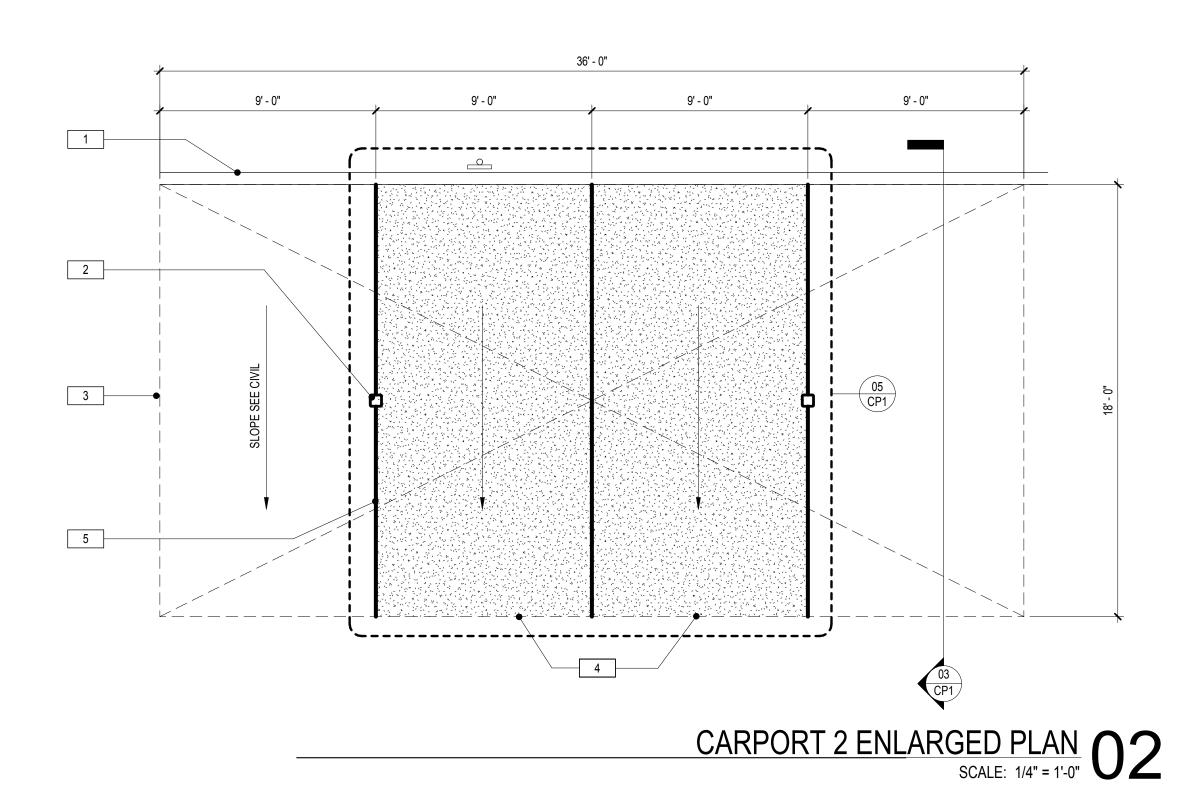

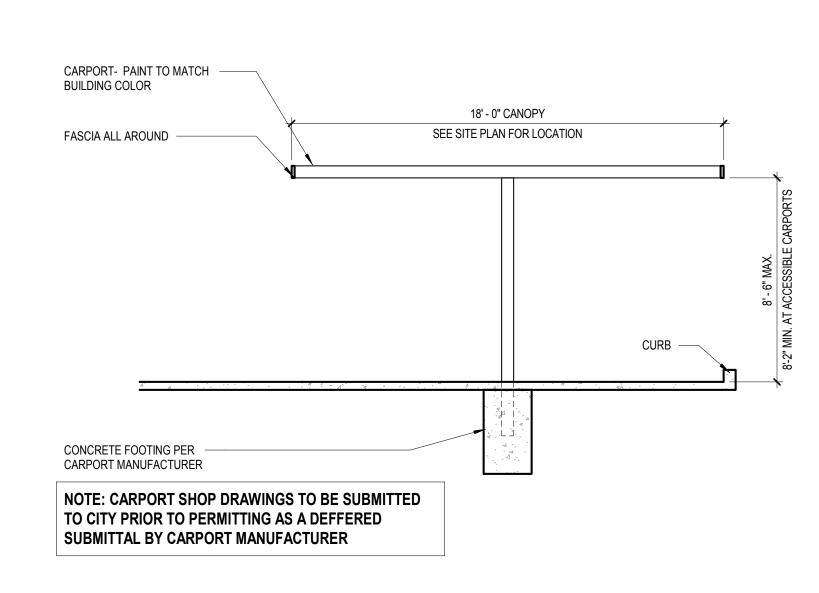

CARPORT SECTION SCALE: 1/4" = 1'-0"

CARPORT 1 ENLARGED PLAN SCALE: 1/4" = 1'-0"

KEY
VALUE

KEYNOTE TEXT

1 CONCRETE CURB, SEE CIVIL PLANS
2 STEEL CARPORT POST BY MANUFACTURER
3 PREFAB STEEL CARPORT BY MANUFACTURER
4 ACCESSIBLE STALL & PASSENGER LOADING PER DETAILS, SEE SITE PLAN FOR LOCATIONS
5 STRIPING PER STANDARDS, SEE CIVIL PLANS



<del>-</del>

Architect

ARCHITECTURE & PLANNING

THOMAS OCHSNER

2017 BY THOMAS OCHSNER. ALL RIGHTS RESERVED.

### Thomas Ochsner AIA Architect

10 E. Yanonali Street Suite 2D Santa Barbara, CA 93101 Tel 805.770.7576 Cel 805.705.6558 tom@toarchitect.com www.toarchitect.com

CLIENT

WESTAR ASSOCIATES

PROJECT

HOLLISTER VILLAGE APARTMENTS

7000 HOLLISTER AVE. GOLETA, CA 93117

HOLLISTER VILLAGE

SHEET TITLE

CARPORT DRAWINGS

SUBMITTALS/ REVISIONS



PROJECT #


PROJECT NAME

HOLLISTER VILLAGE APARTMENTS

DATE DRAWN

DATE 1/15/2019

SHEET NO.

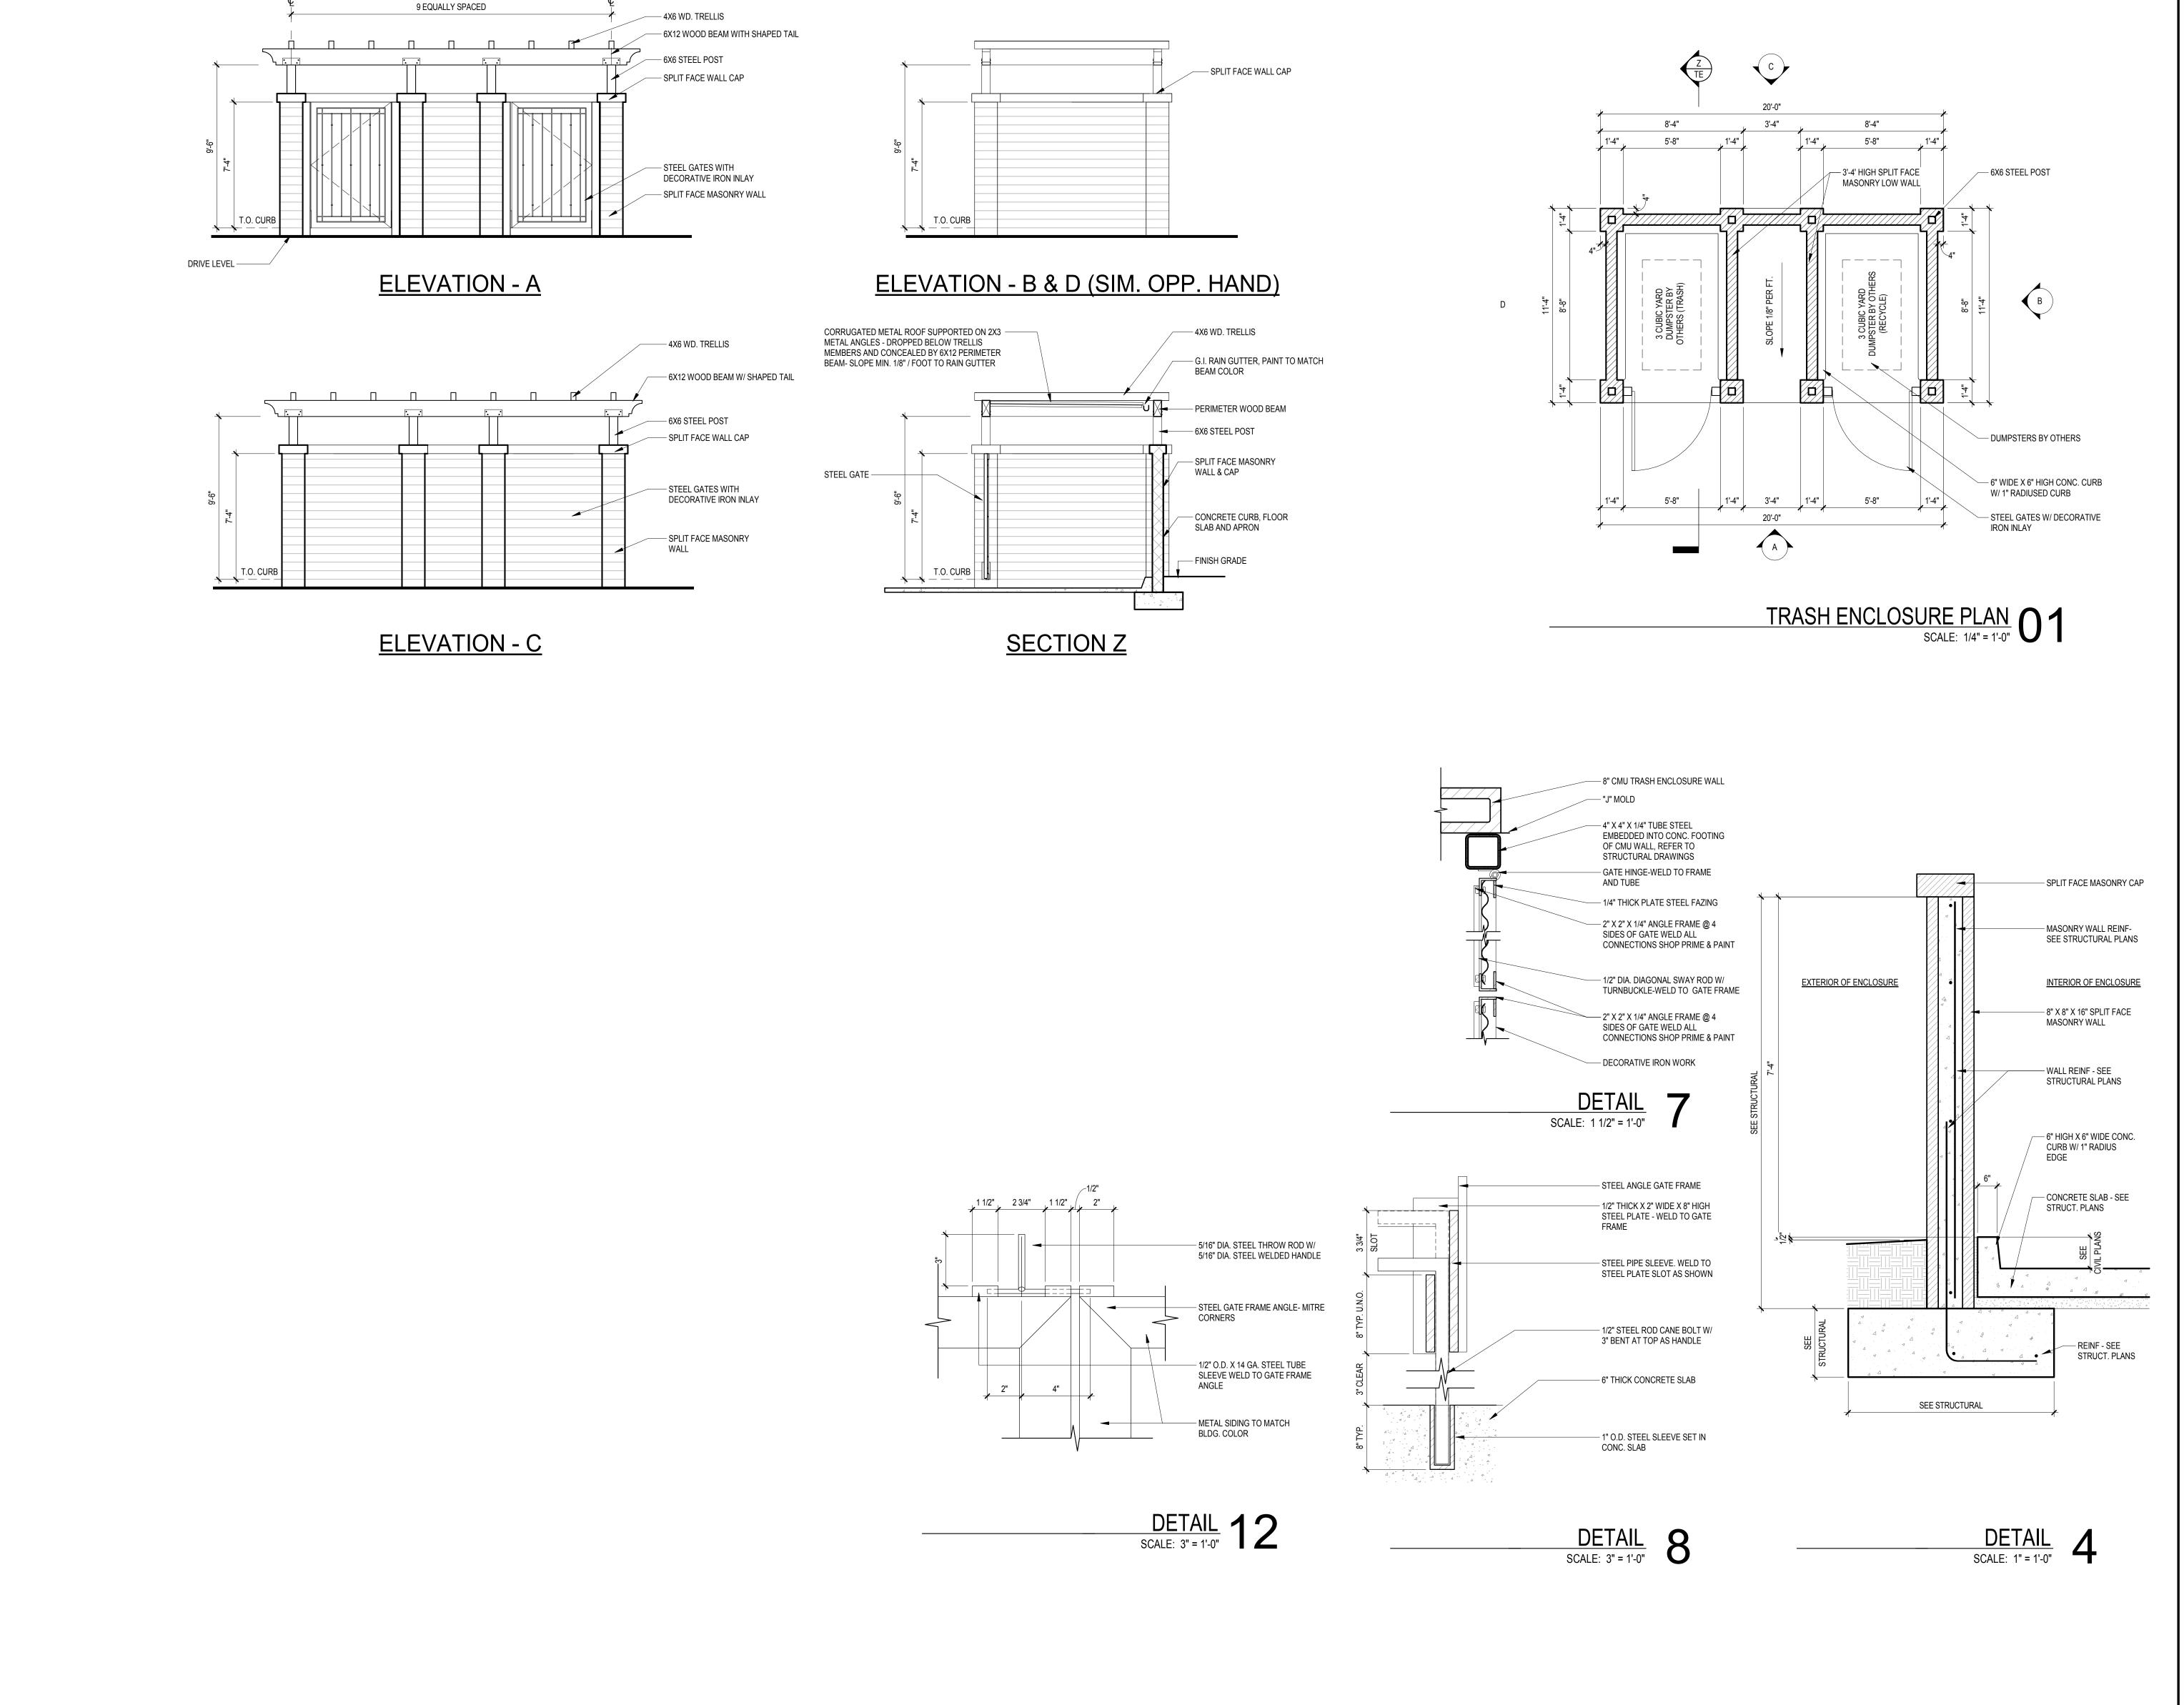

COPYIRIGHI.
2017 BY THOMAS OCHSNER.
ALL RIGHTS RESERVED.
NO PART OF THIS DRAWING MAY
BE
REPRODUCED.

THOMAS OCHSNER Architect

Thomas
Ochsner AIA

10 E. Yanonali Street
Suite 2D
Santa Barbara, CA
93101
Tel 805.770.7576
Cel 805.705.6558
tom@toarchitect.com
www.toarchitect.com

CLIENT

WESTAR ASSOCIATES

PROJECT

HOLLISTER VILLAGE APARTMENTS

7000 HOLLISTER AVE. GOLETA, CA 93117

HOLLISTER VILLAGE

SHEET TITLE

TRASH ENCLOSURE

SUBMITTALS/ REVISIONS

APPLICATION COMPLETENESS 1/15/2019



PROJECT #

PROJECT NAME HOLLISTER VILLAGE APARTMENTS


DATE DRAWN

DATE 1/15/2019

SHEET NO.

TE



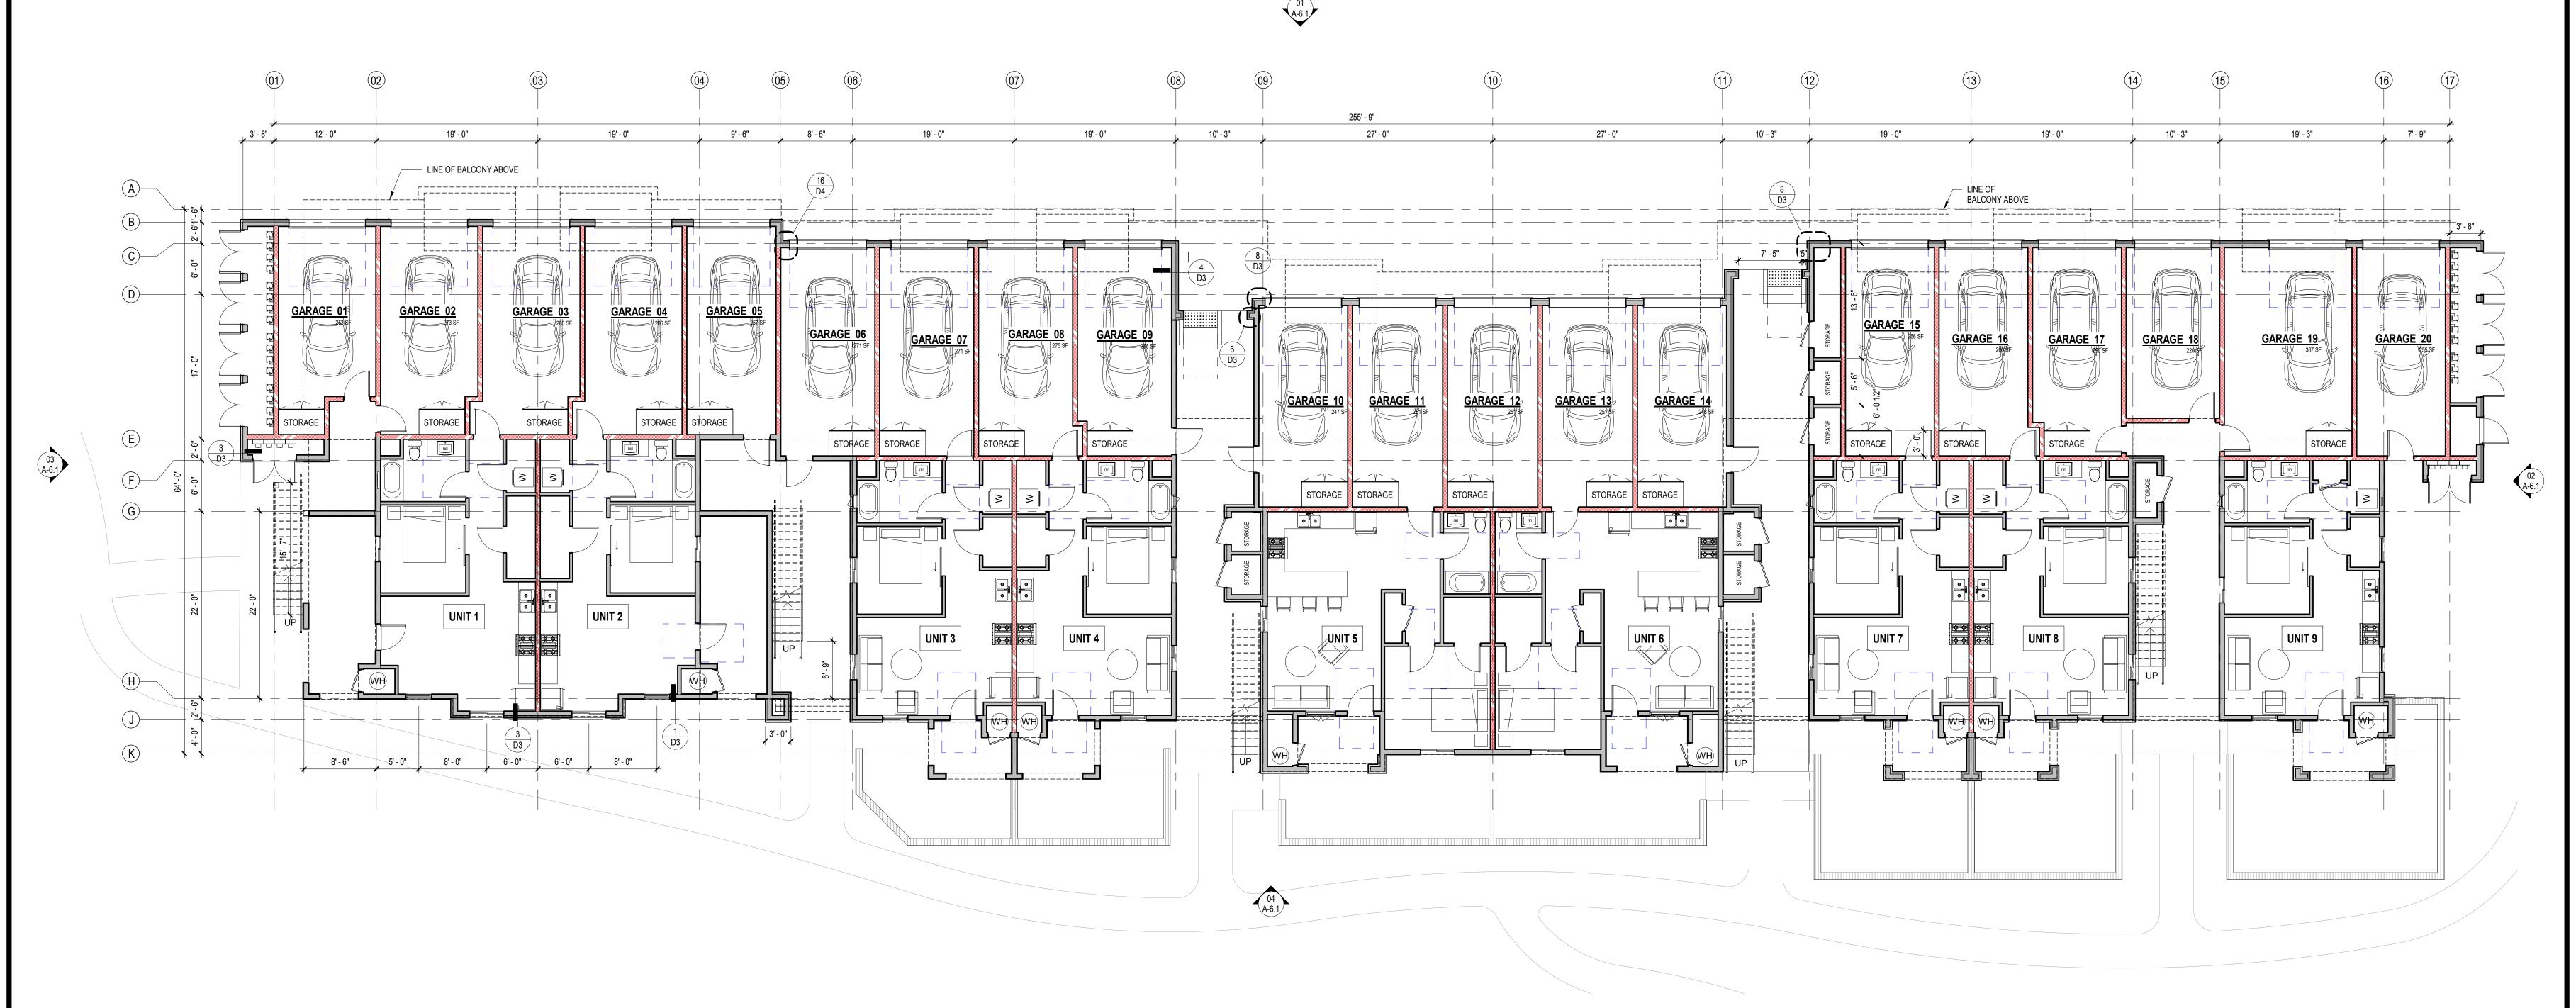

LEVEL 1 FLOOR PLAN

SCALE: 1/8" = 1'-0"





THOMAS OCHSNER Architect

ARCHITECTURE & PLANNING

## Thomas Ochsner AIA Architect

10 E. Yanonali Street
Suite 2D
Santa Barbara, CA
93101
Tel 805.770.7576
Cel 805.705.6558
tom@toarchitect.com
www.toarchitect.com

CLIENT

WESTAR ASSOCIATES

PROJECT

HOLLISTER VILLAGE APARTMENTS

7000 HOLLISTER AVE. GOLETA, CA 93117

HOLLISTER VILLAGE

SHEET TITLE

LEVEL 1 FLOOR PLAN

SUBMITTALS/ REVISIONS

PLANNING SUBMITTAL
APPLICATION COMPLETENESS

C - 22199 =

PROJECT #

PROJECT NAME


HOLLISTER VILLAGE APARTMENTS


DATE DRAWN

DATE 1/15/2019


SHEET NO.

A-2.1

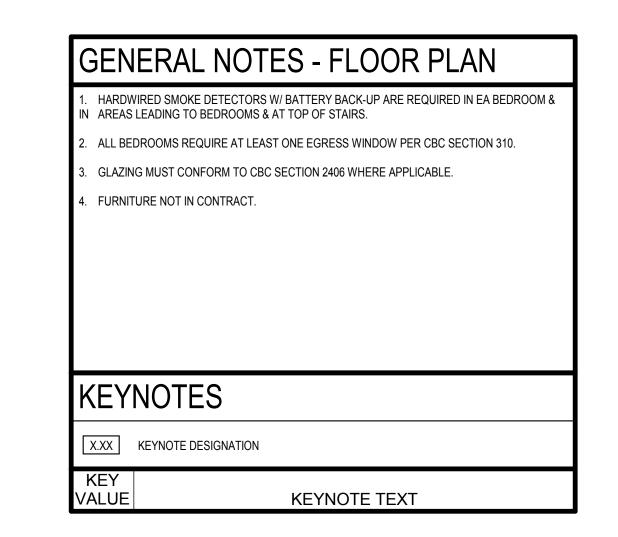

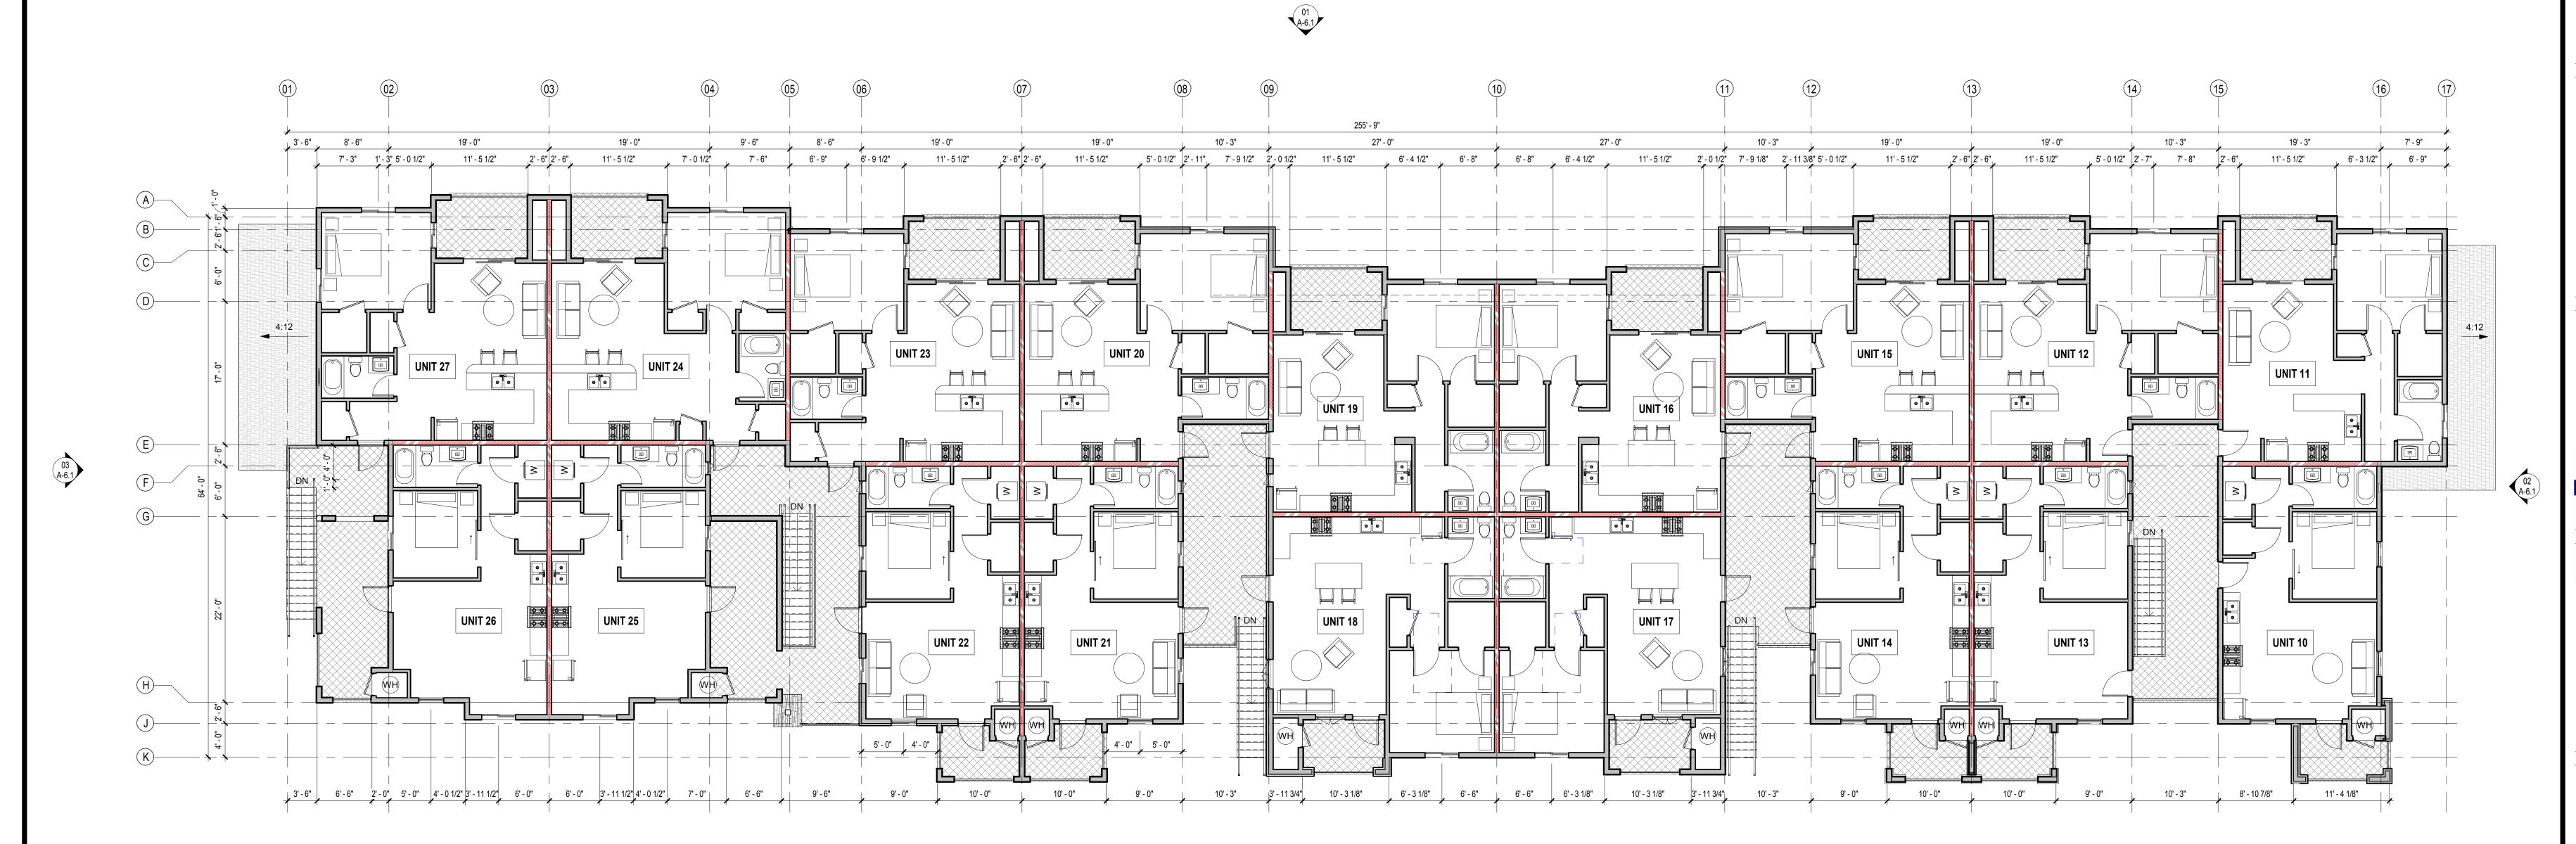

04 A-6.1

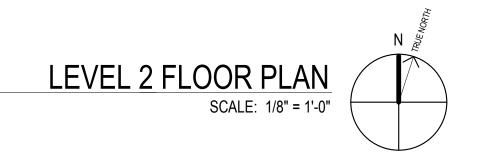

COPYTRIGHT.
2017 BY THOMAS OCHSNER.
ALL RIGHTS RESERVED.
NO PART OF THIS DRAWING MAY
BE
REPRODUCED.



THOMAS OCHSNER
Architect

ARCHITECTURE & PLANNING

Thomas

Ochsner AIA
Architect

10 E. Yanonali Street
Suite 2D
Santa Barbara, CA
93101
Tel 805.770.7576
Cel 805.705.6558
tom@toarchitect.com
www.toarchitect.com

CLIENT

WESTAR ASSOCIATES

PROJECT

HOLLISTER VILLAGE APARTMENTS

7000 HOLLISTER AVE. GOLETA, CA 93117

HOLLISTER VILLAGE

SHEET TITLE

LEVEL 2 FLOOR PLAN

SUBMITTALS/ REVISIONS

PLANNING SUBMITTAL
APPLICATION COMPLETENESS



PROJECT #

PROJECT NAME

HOLLISTER VILLAGE APARTMENTS

DATE DRAWN

SHEET NO.

DATE 1/15/2019

A-2.4




 PROVIDE FLASHING (8" MIN. LAP) AT ROOF JOINTS, COORDINATE FLASHING MATERIAL SELECTION W/ ARCHITECT, TYP.


2. COORINDATE LOCATION OF (N) VENT RISERS WITH ARCHITECT.


3. ROOF DRAINS AND OVERFLOW DRAINS, WHERE CONCEALED WITHIN THE CONSTRUCTION OF THE BUILDING, SHALL BE INSTALLED IN ACCORDANCE WITH THE PLUMBING CODE [2010 CBC SECTION 506.4]

4. ATTIC VENT AREA & CALCULATIONS [PER 2010 CBC SECTION 1505.3]

NOTE: ENCLOSED ATTICS & ENCLOSED RAFTER SPACES FORMED WHERE CEILINGS ARE APPLIED DIRCTLY TO THE UNDERSIDE OF ROOF RAFTERS SHALL HAVE CROSS VENTILATION FOR EACH SEPARATE SPACE BY VENTING OPENINGS PROTECTED AGAINST THE ENTRANCE OF RAIN AND SNOW. THE NET FREE VENTILATION AREA SHALL NOT BE LESS THAN 1/300TH OF THE SPACE VENTILATED PROVIDED A VAPOR BARRIER NOT EXCEEDING (1) PERM IS INSTALLED ON THE WARM SIDE OF THE ATTIC INSULATION.

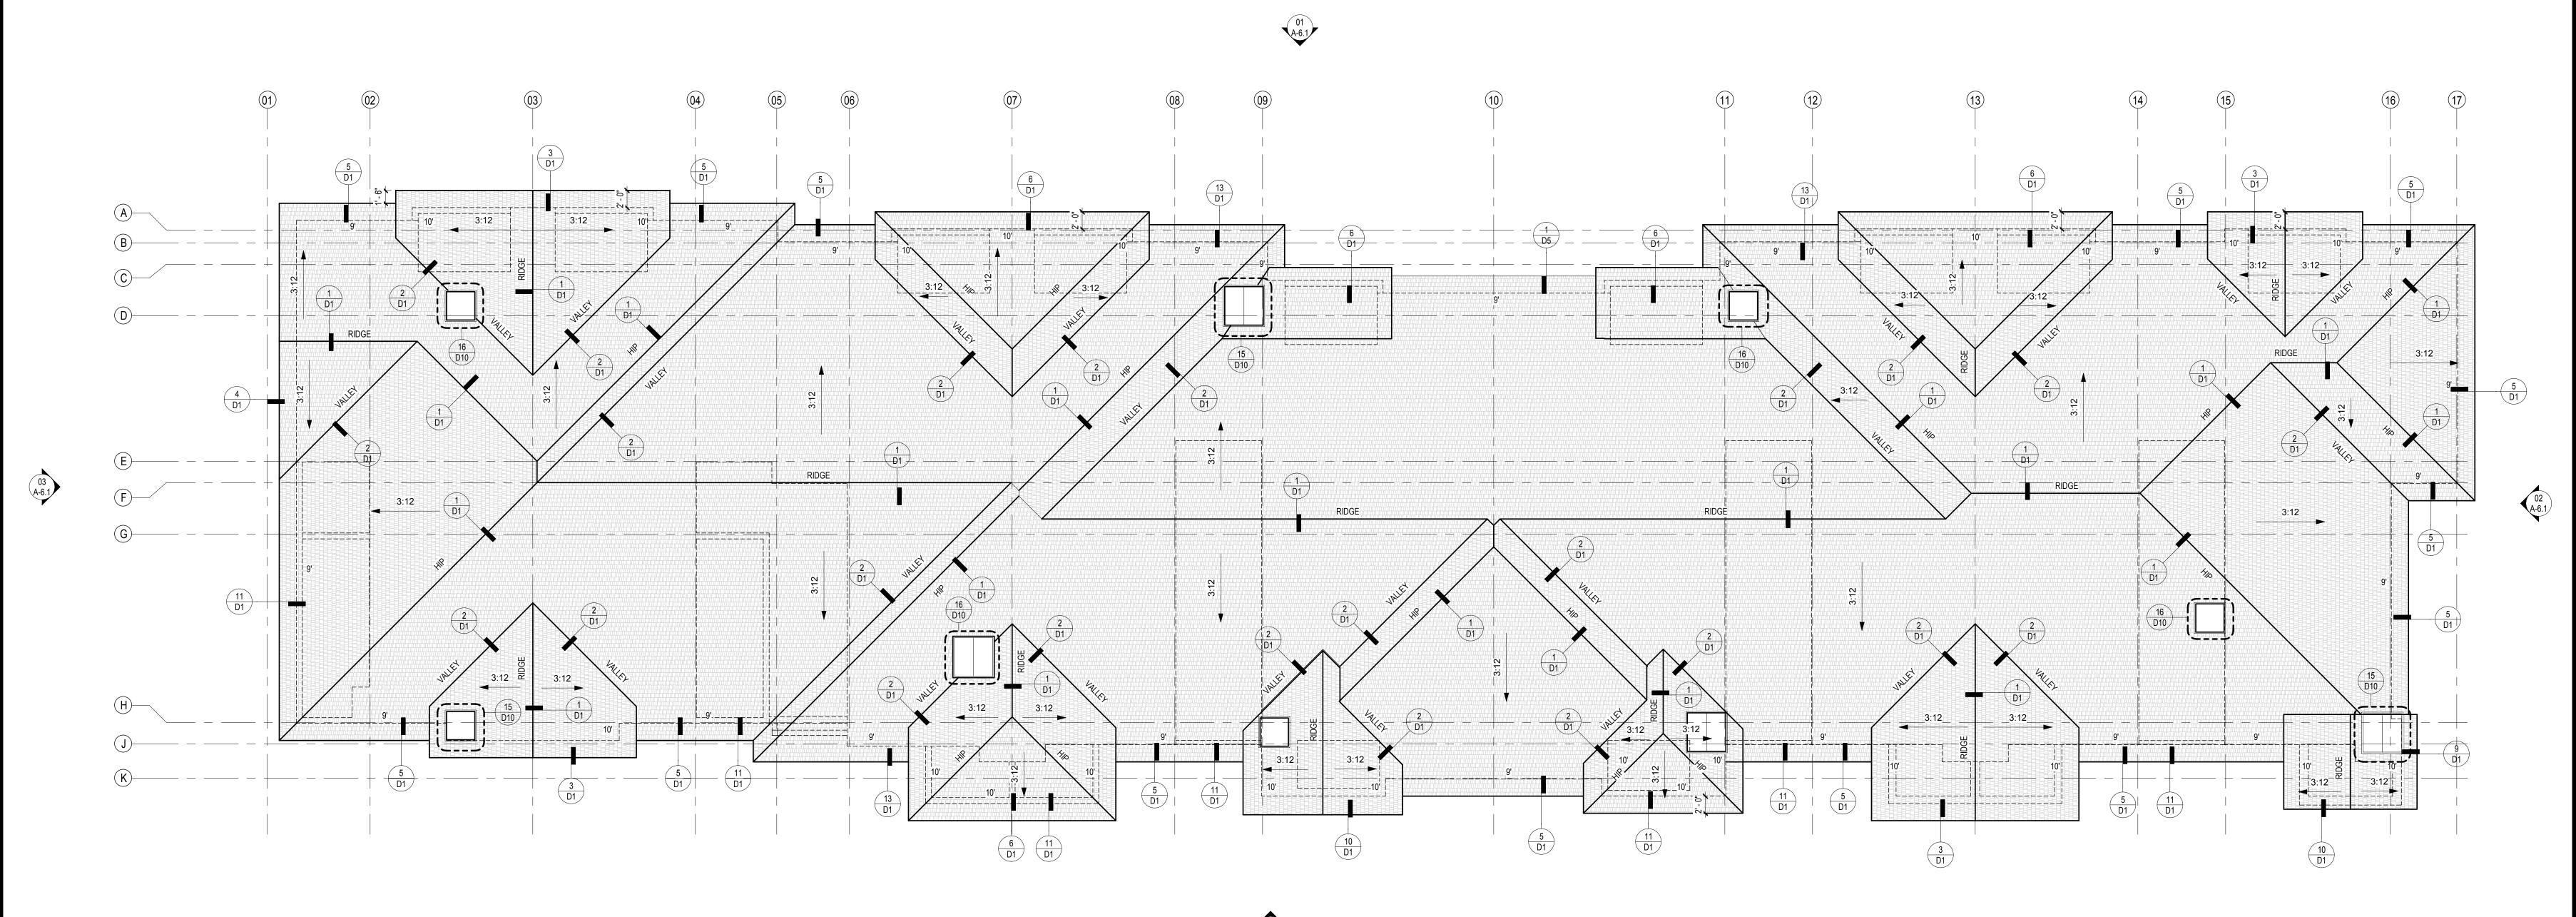

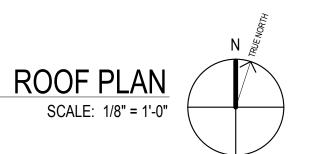

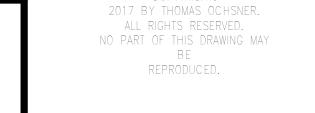



THOMAS OCHSNER Architect

ARCHITECTURE & PLANNING

Thomas

## Ochsner AIA Architect 10 E. Yanonali Street

Suite 2D
Santa Barbara, CA
93101
Tel 805.770.7576
Cel 805.705.6558
tom@toarchitect.com
www.toarchitect.com

CLIENT

WESTAR ASSOCIATES

PROJECT

HOLLISTER VILLAGE APARTMENTS

7000 HOLLISTER AVE. GOLETA, CA 93117

HOLLISTER VILLAGE

SHEET TITLE

ROOF PLAN

SUBMITTALS/ REVISIONS

PLANNING SUBMITTAL
APPLICATION COMPLETENESS

TTAL 11/27/201 MPLETENESS 1/15/2019




PROJECT #
PROJECT NAME
HOLLISTER VILLAGE APARTMENTS


DATE DRAWN

DATE 1/15/2019


SHEET NO.

Λ\_/ 1

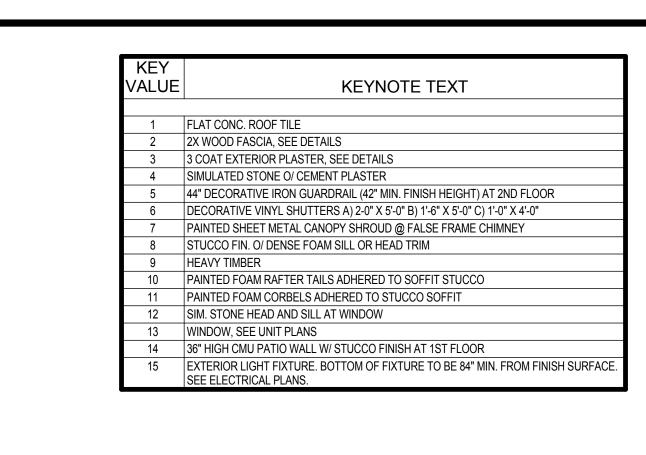


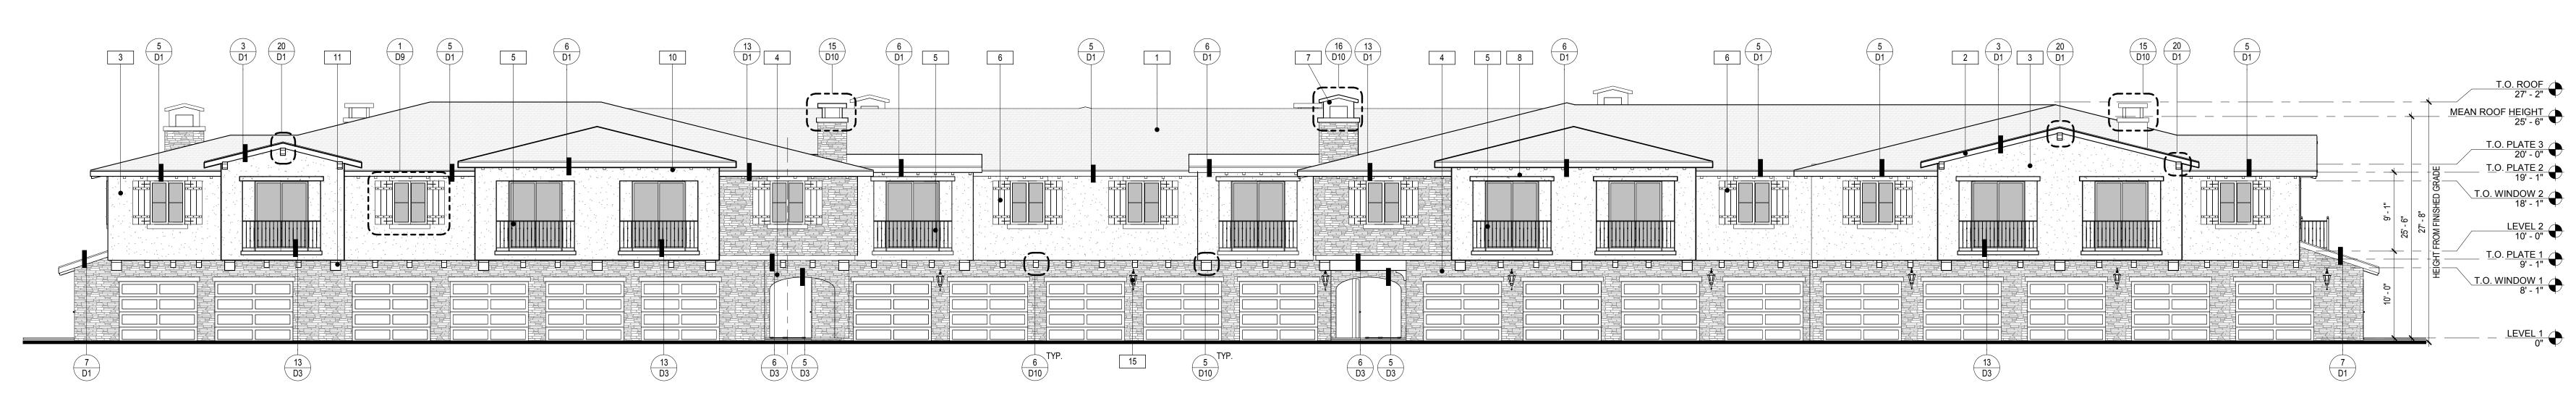


NORTH ELEVATION 1 SCALE: 1/8" = 1'-0"

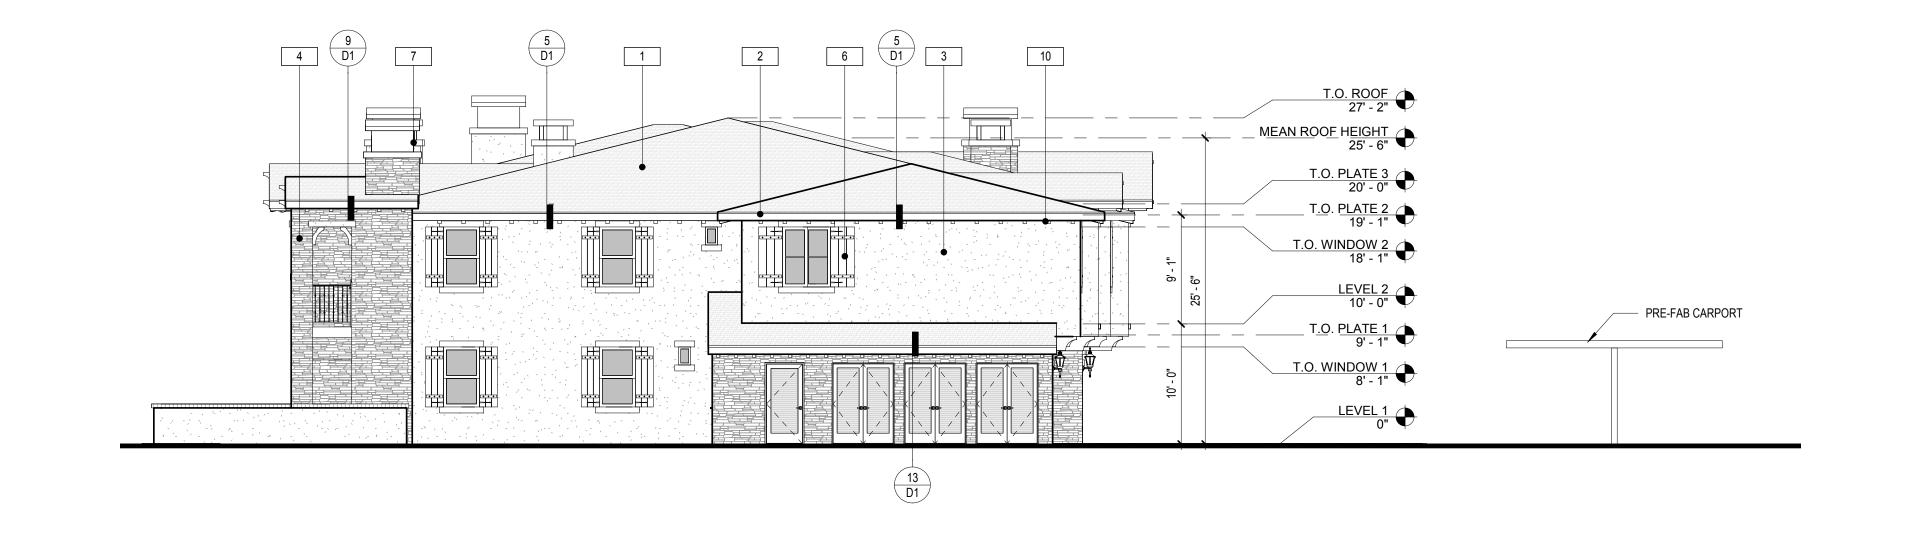


EAST ELEVATION SCALE: 1/8" = 1'-0"

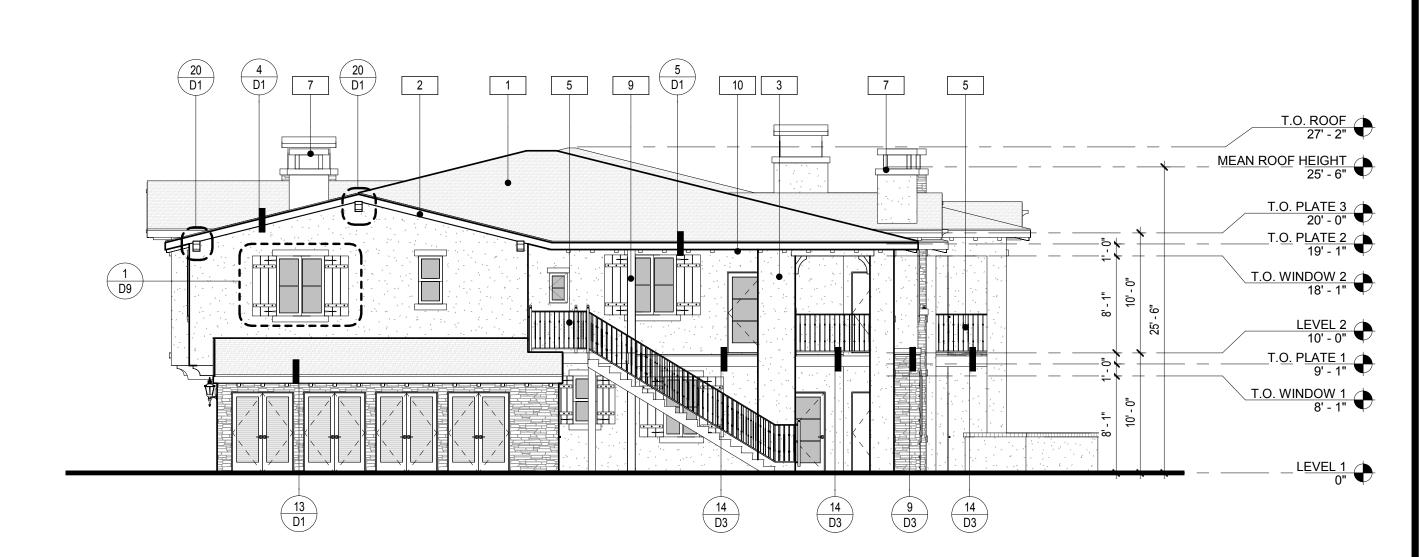

WEST ELEVATION SCALE: 1/8" = 1'-0"

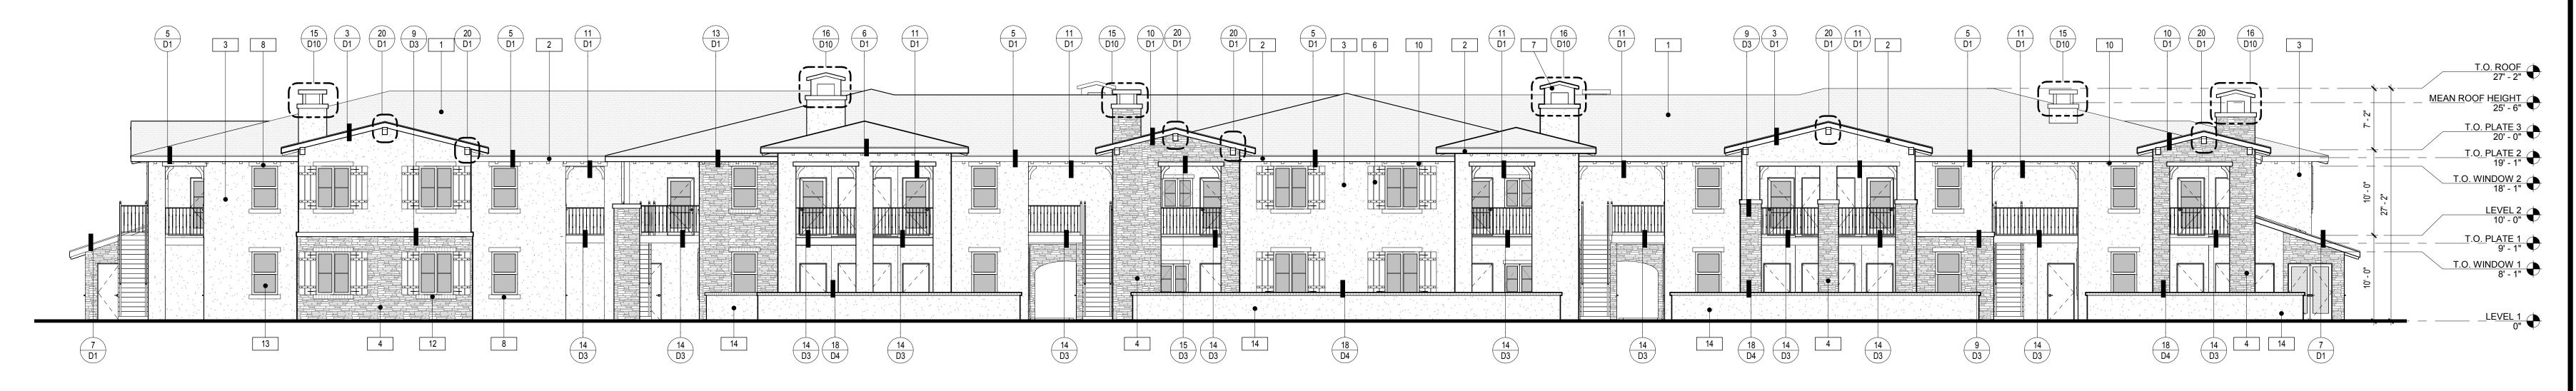

SOUTH ELEVATION SCALE: 1/8" = 1'-0"

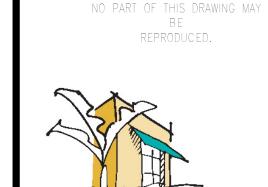

THOMAS OCHSNER Architect

2017 BY THOMAS OCHSNER. ALL RIGHTS RESERVED.

### ARCHITECTURE & PLANNING Thomas Ochsner AIA

10 E. Yanonali Street Suite 2D Santa Barbara, CA Tel 805.770.7576 Cel 805.705.6558 tom@toarchitect.com www.toarchitect.com

CLIENT

WESTAR ASSOCIATES

PROJECT

HOLLISTER VILLAGE **APARTMENTS** 

7000 HOLLISTER AVE. GOLETA, CA 93117

HOLLISTER VILLAGE SHEET TITLE

**EXTERIOR ELEVATIONS** 

SUBMITTALS/ REVISIONS

PLANNING SUBMITTAL
APPLICATION COMPLETENESS



PROJECT# PROJECT NAME

HOLLISTER VILLAGE APARTMENTS DATE DRAWN DATE 1/15/2019

A-6.1

SHEET NO.